

GENERAL NOTES

ALL WORK SHALL BE PERFORMED IN ACCORDANCE WITH THE REQUIREMENTS SET FORTH IN THE NEW JERSEY UNIFORM CONSTRUCTION CODE (NJAC 5:23) AND ALL APPLICABLE MODEL BUILDING SUBCODES, INCLUDING BUT NOT LIMITED TO:
NEW JERSEY INTERNATIONAL BUILDING CODE, 2018
ICC/ANSI 117.1, 2009 ACCESSIBLE AND USABLE BUILDING AND FACILITIES INTERNATIONAL MECHANICAL CODE, 2018
NATIONAL ELECTRICAL CODE, 2017
NATIONAL STANDARD PLUMBING CODE, 2018

ALL WORK SHALL BE PERFORMED DURING NORMAL WORK HOURS, AS SET FORTH IN THE MUNICIPAL ORDINANCE WHICH HOLDS JURISDICTION OVER THE AREA OF WORK, UNLESS SPECIFICALLY PROVIDED OTHERWISE IN THESE CONTRACT DOCUMENTS, SPECIFICATIONS, OR OTHER WRITTEN AGREEMENTS BETWEEN OWNER AND CONTRACTOR.

THE CONTRACTOR SHALL VISIT THE SITE AND VERIFY ALL DIMENSIONS PRIOR TO COMMENCEMENT OF WORK AND NOTIFY THE ARCHITECT IMMEDIATELY OF ANY DISCREPANCIES.

THE CONTRACTOR SHALL MAINTAIN A CLEAN WORK-SITE AND PROTECT ALL BUILDING MATERIALS FROM THE ELEMENTS AND FROM ON-GOING CONSTRUCTION WORK AS NECESSARY TO MAINTAIN THE MATERIAL INTEGRITY.

THE AREA OF WORK SHALL BE SEPARATED FROM ALL OTHER OCCUPIED AREAS BY MINIMUM 6 MIL POLY ETHYLENE DUST CURTAIN. WHERE AREAS OF WORK ARE ADJACENT TO PUBLIC AREAS TO BE OCCUPIED AND CONSTRUCTION PARTITIONS ARE NOT SPECIFIED IN OTHER AREAS OF THESE CONSTRUCTION DOCUMENTS AND SPECIFICATIONS, THE AREA OF WORK SHALL BE SEPARATED BY A UL DESIGN 1445 ONE HOUR CONSTRUCTION PARTITION FROM FLOOR TO CEILING ABOVE THE MIN. 5/8" G.W.B. EACH SIDE OF 3-5/8" METAL STUD FRAMING AT 16" O.C. AND 3" S.A.F.B. IN THE STUD CAVITY. ALL CONSTRUCTION PARTITION REQUIREMENTS SHALL COMPLY WITH NJAC 5:23-9.6(C) IN ALL CASES.

WHEN NOT SPECIFICALLY INDICATED IN THE CONTRACT DOCUMENTS, ALL SITE WORK SHALL COMPLY WITH THE REQUIREMENTS OF THE MUNICIPALITY HAVING JURISDICTION OVER THE PROJECT AREA AND ICC/ANSI 117.1, 2009

ALL LANDSCAPING SHALL BE INSTALLED AT SUCH TIME SO AS TO BE IN HEALTHY CONDITION AT THE TIME OF SUBSTANTIAL COMPLETION. ANY LANDSCAPE MATERIALS NOT IN SUCH CONDITION AT THE TIME OF SUBSTANTIAL COMPLETION SHALL BE REPLACED BY THE CONTRACTOR AT NO COST TO THE OWNER. THE CONTRACTOR SHALL COORDINATE WITH THE OWNER, GROWING SEASON, AND CONSTRUCTION SCHEDULE IN SCHEDULING INSTALLATIONS AFTER SUBSTANTIAL COMPLETION.

ALL BEARING SOIL SHALL BE UNDISTURBED OR 100% COMPACTED SOIL TO ACCOMMODATE THE INSTALLATION OF FOOTINGS, FOUNDATION WALLS, PILING, ETC. WHEN NOT INDICATED OTHERWISE IN THESE CONTRACT DOCUMENTS AND SPECIFICATIONS VIA SOIL REPORT, BEARING CAPACITY OF THE SOIL IN THE AREA OF WORK SHALL BE CONSIDERED TO BE 3,000 PSI WITHOUT DETRIMENTAL SETTLEMENT. IN SUCH CASES, THE CONTRACTOR SHALL BE RESPONSIBLE TO PROVIDE TESTING TO VERIFY THIS CONDITION PRIOR TO COMMENCEMENT OF WORK.

FOOTINGS SHALL BE LOCATED A MINIMUM OF 30" BELOW GRADE, UNLESS OTHERWISE INDICATED IN THESE DOCUMENTS.

IN PERFORMING ANY EARTHWORK, ALL EXCAVATED AREAS SHALL BE PROVIDED WITH TEMPORARY SUPPORTS AND/OR SHARING TO PREVENT ANY COLLAPSE. EXCAVATED SOILS, FILL, ETC. SHALL BE STORED SO AS NOT TO EXCEED THE ANGLE OF REPOSE FOR EACH TYPE. ALL BEARING SOIL, WHEN EXCAVATED AND STORED SHALL BE PROPERLY PROTECTED FROM THE ELEMENTS UNTIL BACKFILLING.

BACKFILLING SHALL BE PERFORMED IN MAX. 6" LIFTS UNLESS OTHERWISE INDICATED IN THESE DOCUMENTS. EACH LIFT SHALL BE TAMPED PRIOR TO CONTINUING WORK.

ALL MISCELLANEOUS WOOD SHALL BE MIN. NO. 1 OR BETTER DOUGLASS FIR. WOOD NAILERS, BLOCKING, ETC. IN FOUNDATION CONSTRUCTION SHALL BE TREATED TO RESIST DECAY.

ALL CRAWL SPACES AND SLAB ON-GRAD CONDITIONS SHALL BE PROVIDED WITH 6 MIL. POLYETHYLENE VAPOR BARRIER FOR THE ENTIRE FOOTPRINT AND MIN. 24" WIDE 2" RIGID INSULATION AT THE ENTIRE PERIMETER OF THE BUILDING FOOTPRINT.

ALL CONCRETE TO BE PROVIDED SHALL BE MIN. 4,000 PSI IN 28 DAYS UNLESS INDICATED OTHERWISE IN THESE DOCUMENTS.

ALL CONCRETE MASONRY UNITS WHEN LOAD-BEARING SHALL CONFORM TO ASTM C34-B4. IN NON-LOAD-BEARING APPLICATIONS MASONRY UNITS SHALL COMPLY WITH C56-B1.

ALL DOORS AND WINDOWS AT EXTERIOR WALLS SHALL BE PROVIDED WITH ALUM. SILL FLASHING UNDER THE ENTIRE WIDTH OF THE OPENING. AT WINDOW AREAS, FLASHING SHALL HAVE UPTURNED EDGES WITH SOLDERED CORNERS AND PITCH TO THE EXTERIOR. ALL WINDOWS AND DOORS SHALL BE PROVIDED WITH SHIM SPACES AT THE PERIMETER TO ENSURE A PLUMB AND TRUE INSTALLATION.

ALL GLAZING IN HAZARDOUS AREAS AS DEFINED IN 2406.2 SHALL BE TEMPERED GLAZED SAFETY GLASS AND SHALL BE IMPACT-RESISTANT GLAZED OPENINGS.

ALL GYPSUM WALL BOARD TO BE 5/8" FIRECODE "C" UNLESS INDICATED OTHERWISE IN THE DOCUMENTS.

ALL BATHROOM AND KITCHEN AREAS SHALL BE PROVIDED WITH WATER-RESISTANT G.W.B., TYPICAL. ALL TILE AREAS SHALL BE PROVIDED WITH CEMENTITIOUS BOARD BACK-UP UNLESS INDICATED OTHERWISE.

IN ALL PAINTED WALL AREAS, G.W.B. SHALL BE TAPED AND SPACKLED TO MIN. LEVEL 4 FINISH.



IN ALL WALL-COVERED AREAS, G.W.B. SHALL BE TAPED AND SPACKLED TO MIN. LEVEL 4 FINISH.

SHOP DRAWINGS SHALL BE REQUIRED FOR ALL MILLWORK.

ALL THRESHOLDS AND OTHER FLOORING TRANSITIONS SHALL COMPLY WITH THE FLOOR LEVEL CHANGES CONSTITUTED IN ICC/ANSI 117.1, 2009.

ALL SPECIALTIES, ACCESSORIES, OR OTHER WALL-MOUNTED EQUIPMENT, FIXTURES, ETC. SHALL BE PROVIDED WITH NON-COMBUSTIBLE BLOCKING IN THE WALL CAVITY FOR SUPPORT UNLESS SPECIFICALLY NOTED OTHERWISE.

ALL ELEVATOR PITS (WHERE APPLICABLE) SHALL BE PROVIDED WITH SUMP PUMP CONNECTED TO THE BUILDING STORM WATER SYSTEM. THE PIT SHALL BE PROVIDE WITH A GALV. STEEL ACCESS LADDER MOUNTED IN AN OSHA COMPLIANT LOCATION WITH WORK LIGHT AND SWITCH ACCESSIBLE FROM THE POINT OF ENTRY. ALL ELEVATOR DOORS SHALL BE PROVIDED WITH STRUCTURAL STEEL SILL ANGLES AS REQUIRED BY THE MANUFACTURER.

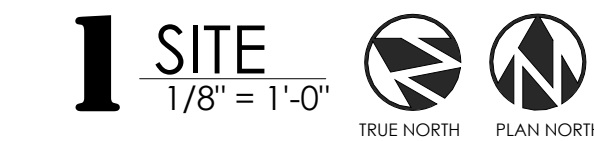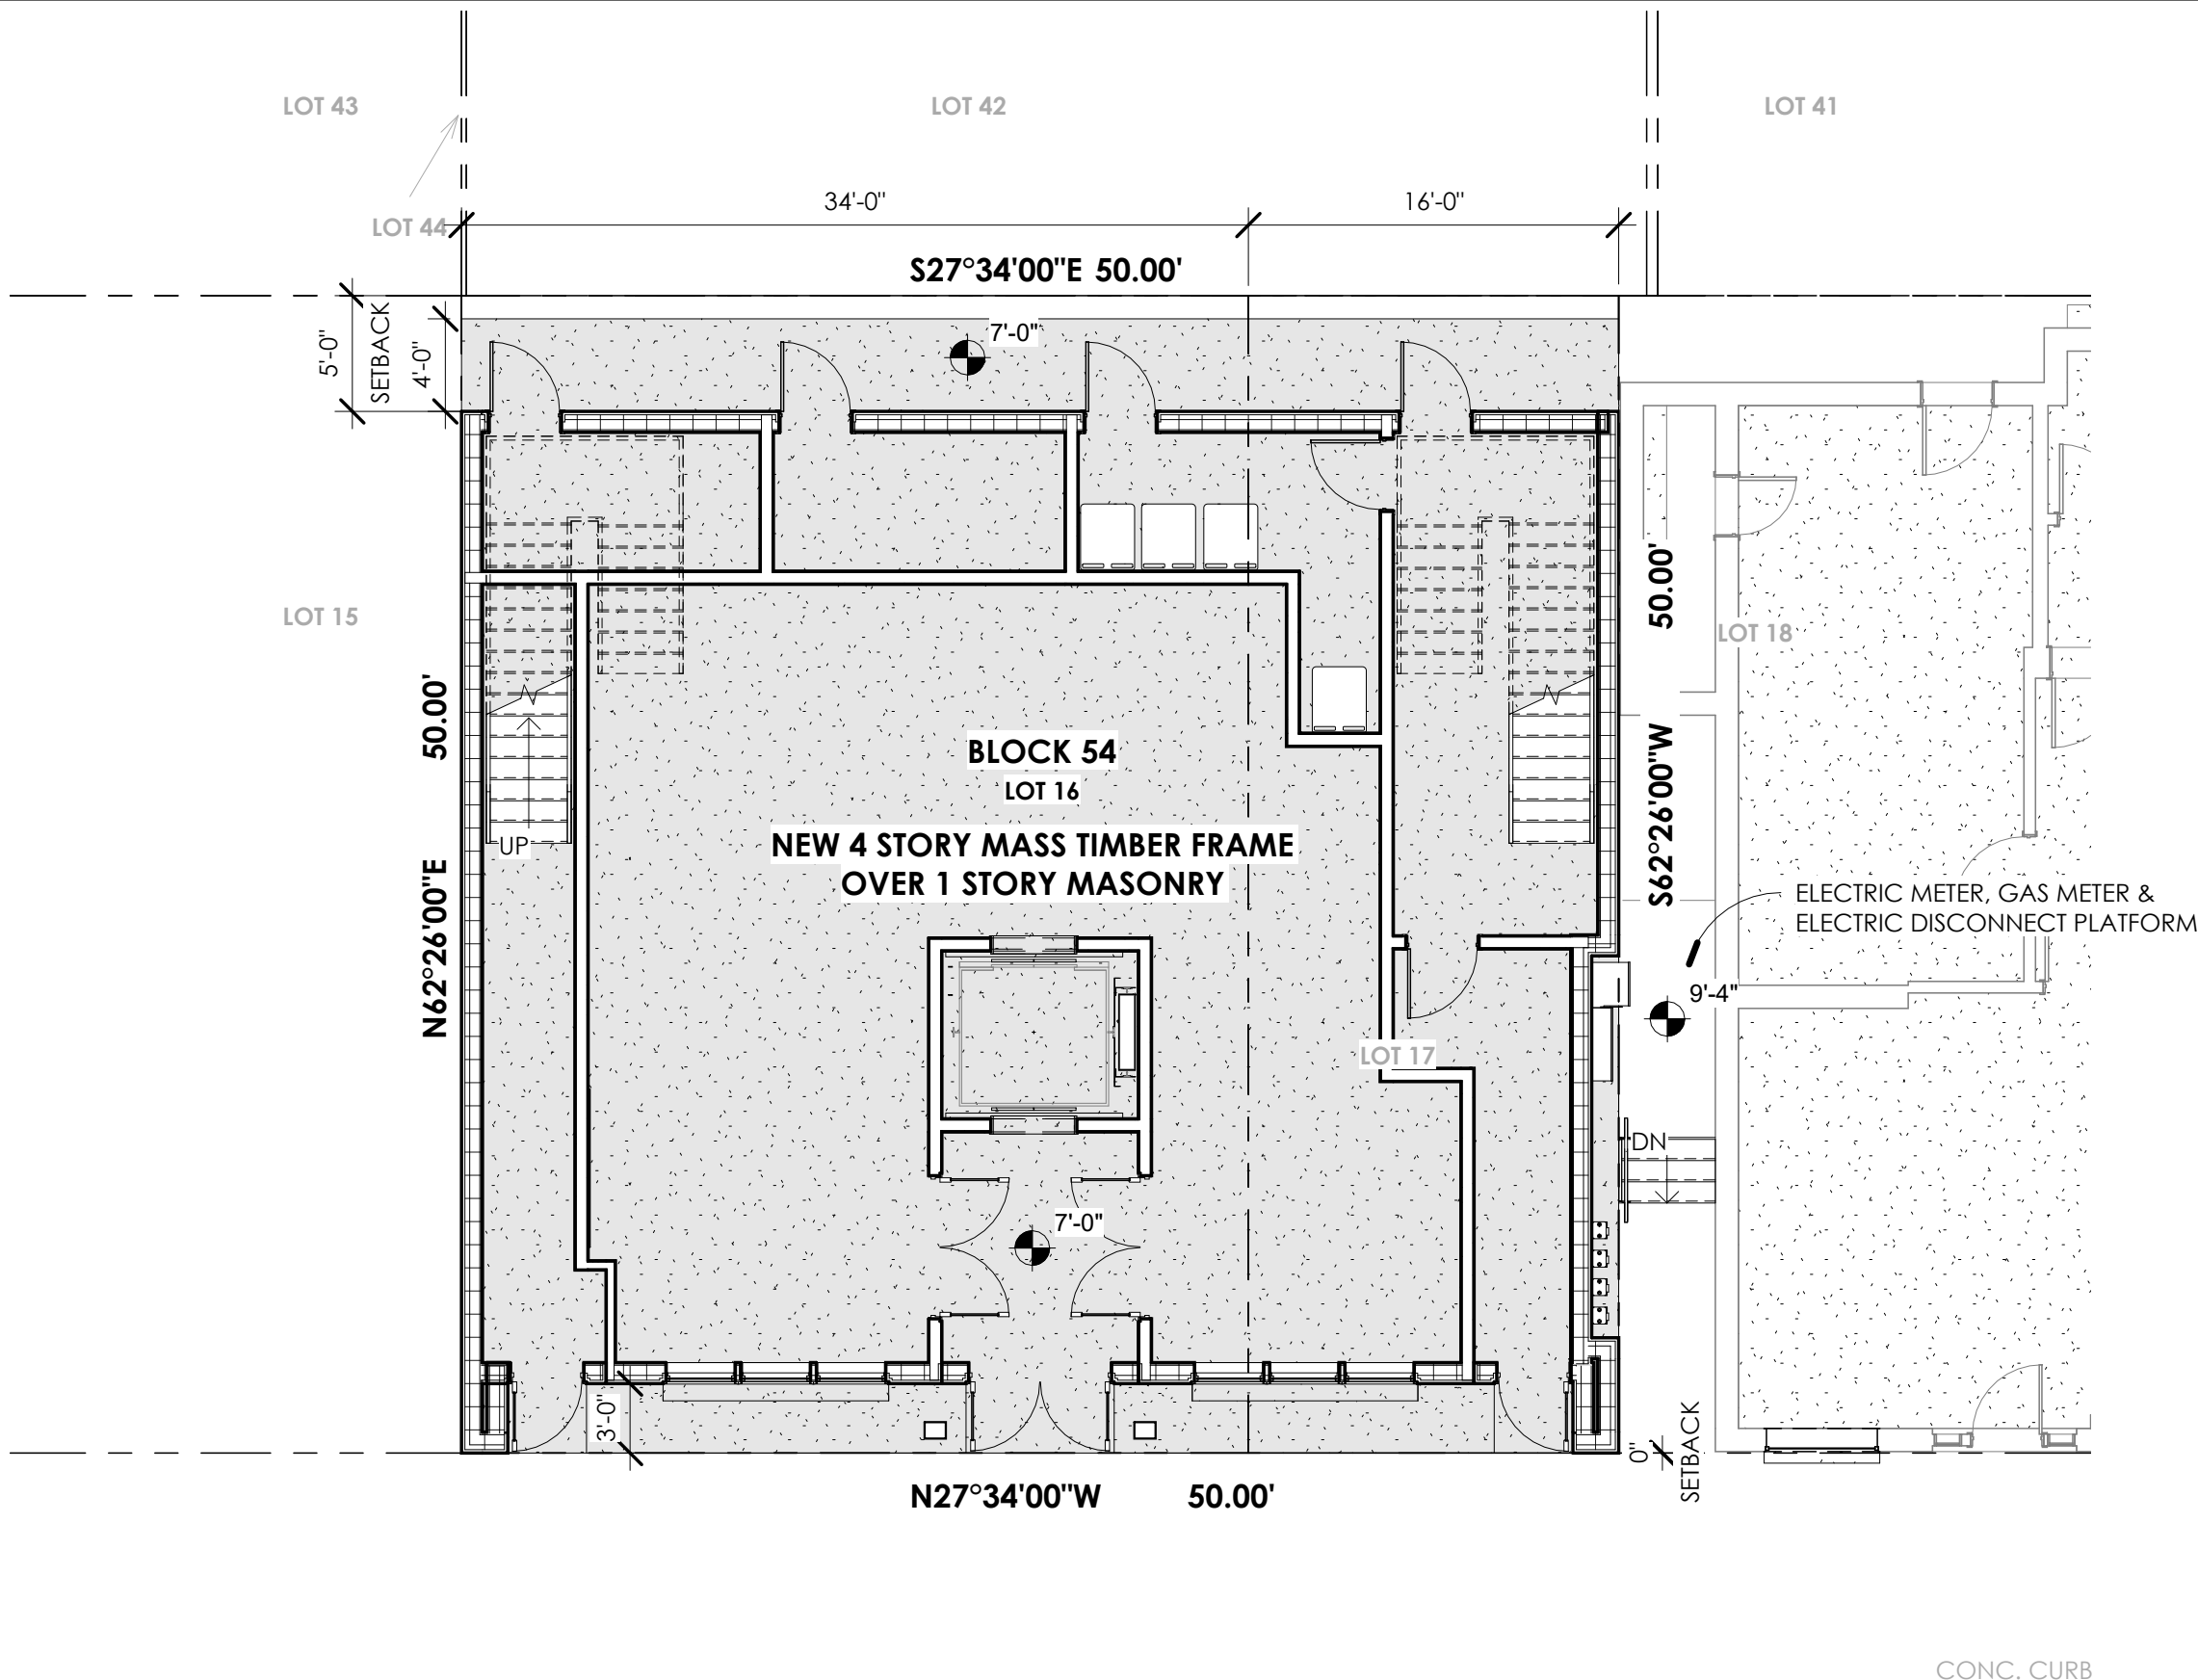

ARCHITECTURE ABBREVIATIONS

AB	ANCHOR BOLT	(E)	EXISTING	INSUL	INSULATION	PNL	PANEL	THK	THICKNESS
ABV	ABOVE	E	EAST	INT	INTERIOR	PRELIM	PRELIMINARY	TH	TOWEL HOOK
A/C	AIR CONDITIONING	EA	EACH	INV	INVERT	PSC	PROJECTION SCREEN	THRES	THRESHOLD
AC	ASPHALTIC CONCRETE	EXP BT	EXPANSION BOLT	J-BOC	JUNCTION BOX	PSI	POUNDS PER CUBIC INCH	THRU	THROUGH
AD	AREA DRAIN	EJ	EXPANSION JOINT	JT	JOIST	PT	PAINT	TO	TOP OF
ADDM	ADDENDUM	EL	ELECTRIC	JAN	JOINT	PNT	PAPER TOWEL DISPENSER	TOF	TOP OF CONCRETE OR CURB
ADJ	ADJUSTABLE	ELEC	ELECTRIC(AL)	JAN	JANITOR CLOSET	PRT	PRESSURE TREATED	TOFF	TOP OF FINISHED FLOOR
AESS	ARCHITECTURALLY EXPOSED	ELEV	ELEVATOR	KO	KNOCKOUT	PTD	PAPER TOWEL DISPENSER	TOS	TOP OF SLAB
AFF	ABOVE FINISHED FLOOR	EMER	EMERGENCY	KPL	KICKPLATE	PTN	PARTITION	TOT	TOTAL
AFG	ABOVE FINISHED GRADE	ENCL	ENCLOSURE	L	LENGTH	QT	QUARRY TILE	TP	TOILET PARTITION
AHU	AIR HANDLING UNIT	ENGR	ENGINEER	LAM	LAMINATE	R	RADIUS	TPD	TOILET PAPER DISPENSER
ALT	ALTERNATE	EP	ELECTRICAL PANEL	LAV	LAVATORY	RA	RISER	TPNG	TOPPING
ALUM	ALUMINUM	EQ	EQUIPMENT	LB	POUND	RA GR	RETURN AIR GRILL	TR	TOWEL RACK
AMT	AMOUNT	EQUIP	EQUIPMENT	LF	LINEAR FOOT OR FEET	RB	RUBBER BASE	THV	THERMAL RESISTANCE VALUE
ANOD	ANODIZE(D)	EXIST	EXISTING	LINO	LINEOLEUM	RCP	REFLECTED CEILING PLAN	TSO	TOILET SEAT COVER DISPENSER
ARCH	ARCHITECT[URAL]	EXH	EXHAUST	LT SW	LIGHT SWITCH	RD	ROOF DRAIN	TWP	TACKABLE WALL PANEL
AUTO	AUTOMATIC	EXP	EXPANSION	LVR	LOUVER	REC	RECESSED	TY	TYPICAL
AWT	ACOUSTIC WALL TREATMENT	EXT	EXTERIOR	M	METER	REF	REFERENCE	UNFIN	UNFINISHED
		F/	FACE OF	MACH	MACHINE	REFL	REFLECTED	UNO	UNLESS OTHERWISE NOTED
		FA	FIRE ALARM	MAS	MASONRY	REINF	REINFORCED	UR	URINAL
		FB	FLAT BAR	MATL	MATERIAL	REQD	REQUIRED	VB	VAPOR BARRIER
		FD	FLOOR DRAIN	MAX	MAXIMUM	RESIL	RESILIENT	VOLT	VOLTAGE
		FDTN	FOUNDATION	MKR BD	MARKER BOARD	REV	REVISION	VR	VAPOR RETARDER
		FE	FIRE EXTINGUISHER	MCP	METAL CEILING PANEL	REVL	RAISED FLOOR SYSTEM	VENT	VENTILATION
		FEC	FIRE EXTINGUISHER CABINET	MECH	MECHANICAL	RM	ROOM	VEST	VESTIBULE
		FIN FLR	FINISH FLOOR	MEMB	MEMBRANE	RND	ROUND	VIF	VERIFY IN FIELD
		FIN	FINISHED	MFG	MANUFACTURER	RO	ROUGH OPENING	VNR	VENEER
		FLASH	FLASHING	MH	MANHOLE	RV	ROOF VENT	VP	VENEER PLASTER
		FLR	FLOOR	MIN	MINIMUM	S	SOUTH	VFY	VERIFY
		FLOUR	FLUORESCENT	MISC	MISCELLANEOUS	SAT	SELF-ADHERED MEMBRANE	W	WEST
		FM	FLOOR MAT	MIR	MIRROR	SC	SUSPENDED ACOUSTICAL TILE	W/	WITH
		FOF	FACE OF FINISH	MTD	MOUNTED	SCHED	SCHEDULE	WC	WATER CLOSET
		FOC	FACE OF CONCRETE	MTL	METAL	SCP	SKIM COAT PLASTER	WD	WOOD
		FOM	FACE OF MASONRY	MWP	METAL WALL PANEL	SCR	SCREEN	WB	WOOD BASE
		FOS	FACE OF STUDS	N	NORTH	SD	SOAP DISPENSER	WDW	WINDOW
		FPRF	FIRE PROTECTION	NA	NOT APPLICABLE	SECT	SECTION	WGL	WIRED GLASS
		FR	FIRE RESISTANT	NIC	NOT IN CONTRACT	SHD	SQUARE FOOT OR FEET	WHTBD	WHEATBOARD
		FRAP	FIREMANS REMOTE	NO	NUMBER	SHD	WINDOW SHADE	WJO	WITHOUT
			ANNUNCIATOR PANEL	NOM	NOMINAL	SHTHG	SHEATHING	WP	WATERPROOFING
			FOOT OR FEET	NTS	NOT TO SCALE	SHT	SHEET	WDP	WOOD PANELING
			FURNITURE			SIM	SIMILAR	WR	WASTE RECEPTACLE
			GROUND			SMK CUR	SMOKE CURTAIN	W.R.A.B.M.	WEATHER RESISTIVE AIR BARRIER
			GAUGE			SND	SANITARY NAPKIN DISPENSER	WSCT	MEMBRANE
			GALVANIZED			SNDU	SANITARY NAPKIN DISPENSER UNIT	WTR	WAINSCOT
			GRAB BAR			SOG	SLAB ON GRADE	WTF	WATER
			GENERAL CONTRACTOR			SPEC	SPECIFICATION	W/W	WALL TO WALL
			GLASS			SQ	SQUARE	WWF	WELDED WIRE FABRIC
			GYPSUM BOARD			SST	STAINLESS STEEL		
						ST	STREET	XFMR	TRANSFORMER
						STD	STANDARD	YD	YARD
						STL	STEEL		
						STN	STAIN		
						STOR	STORAGE		
						STRUCT	STRUCTURAL		
						SURF	SURFACE		
						SUSP	SUSPEND(ED)		
						SV	SHEET VINYL		
						SYM	SYMMETRICAL		
						SYS	SYSTEM		
						T/	TOP OF		
						T	TREAD		
						TOB	TOP OF BEAM		
						TC	TRAFFIC COATING		
						TEMP	TEMPORARY		
						TERM	TERMINATION		
						T&G	TONGUE & GROOVE		

D	DEEP	ICOL	INTEGRAL COLOR
DBL	DOUBLE	ID	INSIDE DIAMETER/DIMENSION
DET	DETAIL	IN	INCH
DF	DRINKING FOUNTAIN	INCL	INCLUDE(D)
DIA	DIAMETER	INFO	INFORMATION
DN	DIMENSION		
DOWN	DOWN		
DR	DOOR		
DRAIN	DRAIN		
DS	DOWNSPOUT		
DWG	DRAWING		



NEW CONSTRUCTION TO:
SURF LODGE
BLOCK 54, LOTS 16 & 17
ATLANTIC CITY, NJ 08401

OWNER: 155 S TENNESSEE QOZB LLC
155 S TENNESSEE AVENUE
ATLANTIC CITY, NJ 08401

ARCHITECT: WILLIAM MCLEES ARCHITECTURE
5 MACARTHUR BOULEVARD
SOMERS POINT, NJ 08244
CONTACT: WILLIAM MCLEES, AIA
609.927.0888

DRAWING LIST

SHEET NUMBER	SHEET NAME	ISSUE DATE	CURRENT REVISION	REVISION DATE
G0.00	COVER SHEET	10.05.22		
A1.11	FLOOR PLANS - 1ST & 2ND FLOOR	10.05.22		
A1.12	FLOOR PLANS - 3RD & 4TH FLOOR	10.05.22	1	10.11.22
A1.13	FLOOR PLANS - 5TH FLOOR & ROOF	10.05.22		
A2.01	ELEVATIONS	10.05.22		
A2.02	ELEVATIONS	10.05.22		

1. ALL SPOT ELEVATIONS ARE TAKEN FROM SEA LEVEL.



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NEW CONSTRUCTION
SURF LODGE

BLOCK 54, LOTS 16 & 17
ATLANTIC CITY, NJ 08401

COVER SHEET

Scale As indicated
Drawn by WSZ
Date 10.05.22

GO.00

Comision no. 21086S



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AIA, LEED AP
New Jersey State License
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NEW CONSTRUCTION SURF LODGE

BLOCK 54, LOTS 16 & 17
ATLANTIC CITY, NJ 08401

No.	Description	Date

FLOOR PLANS - 1ST & 2ND FLOOR


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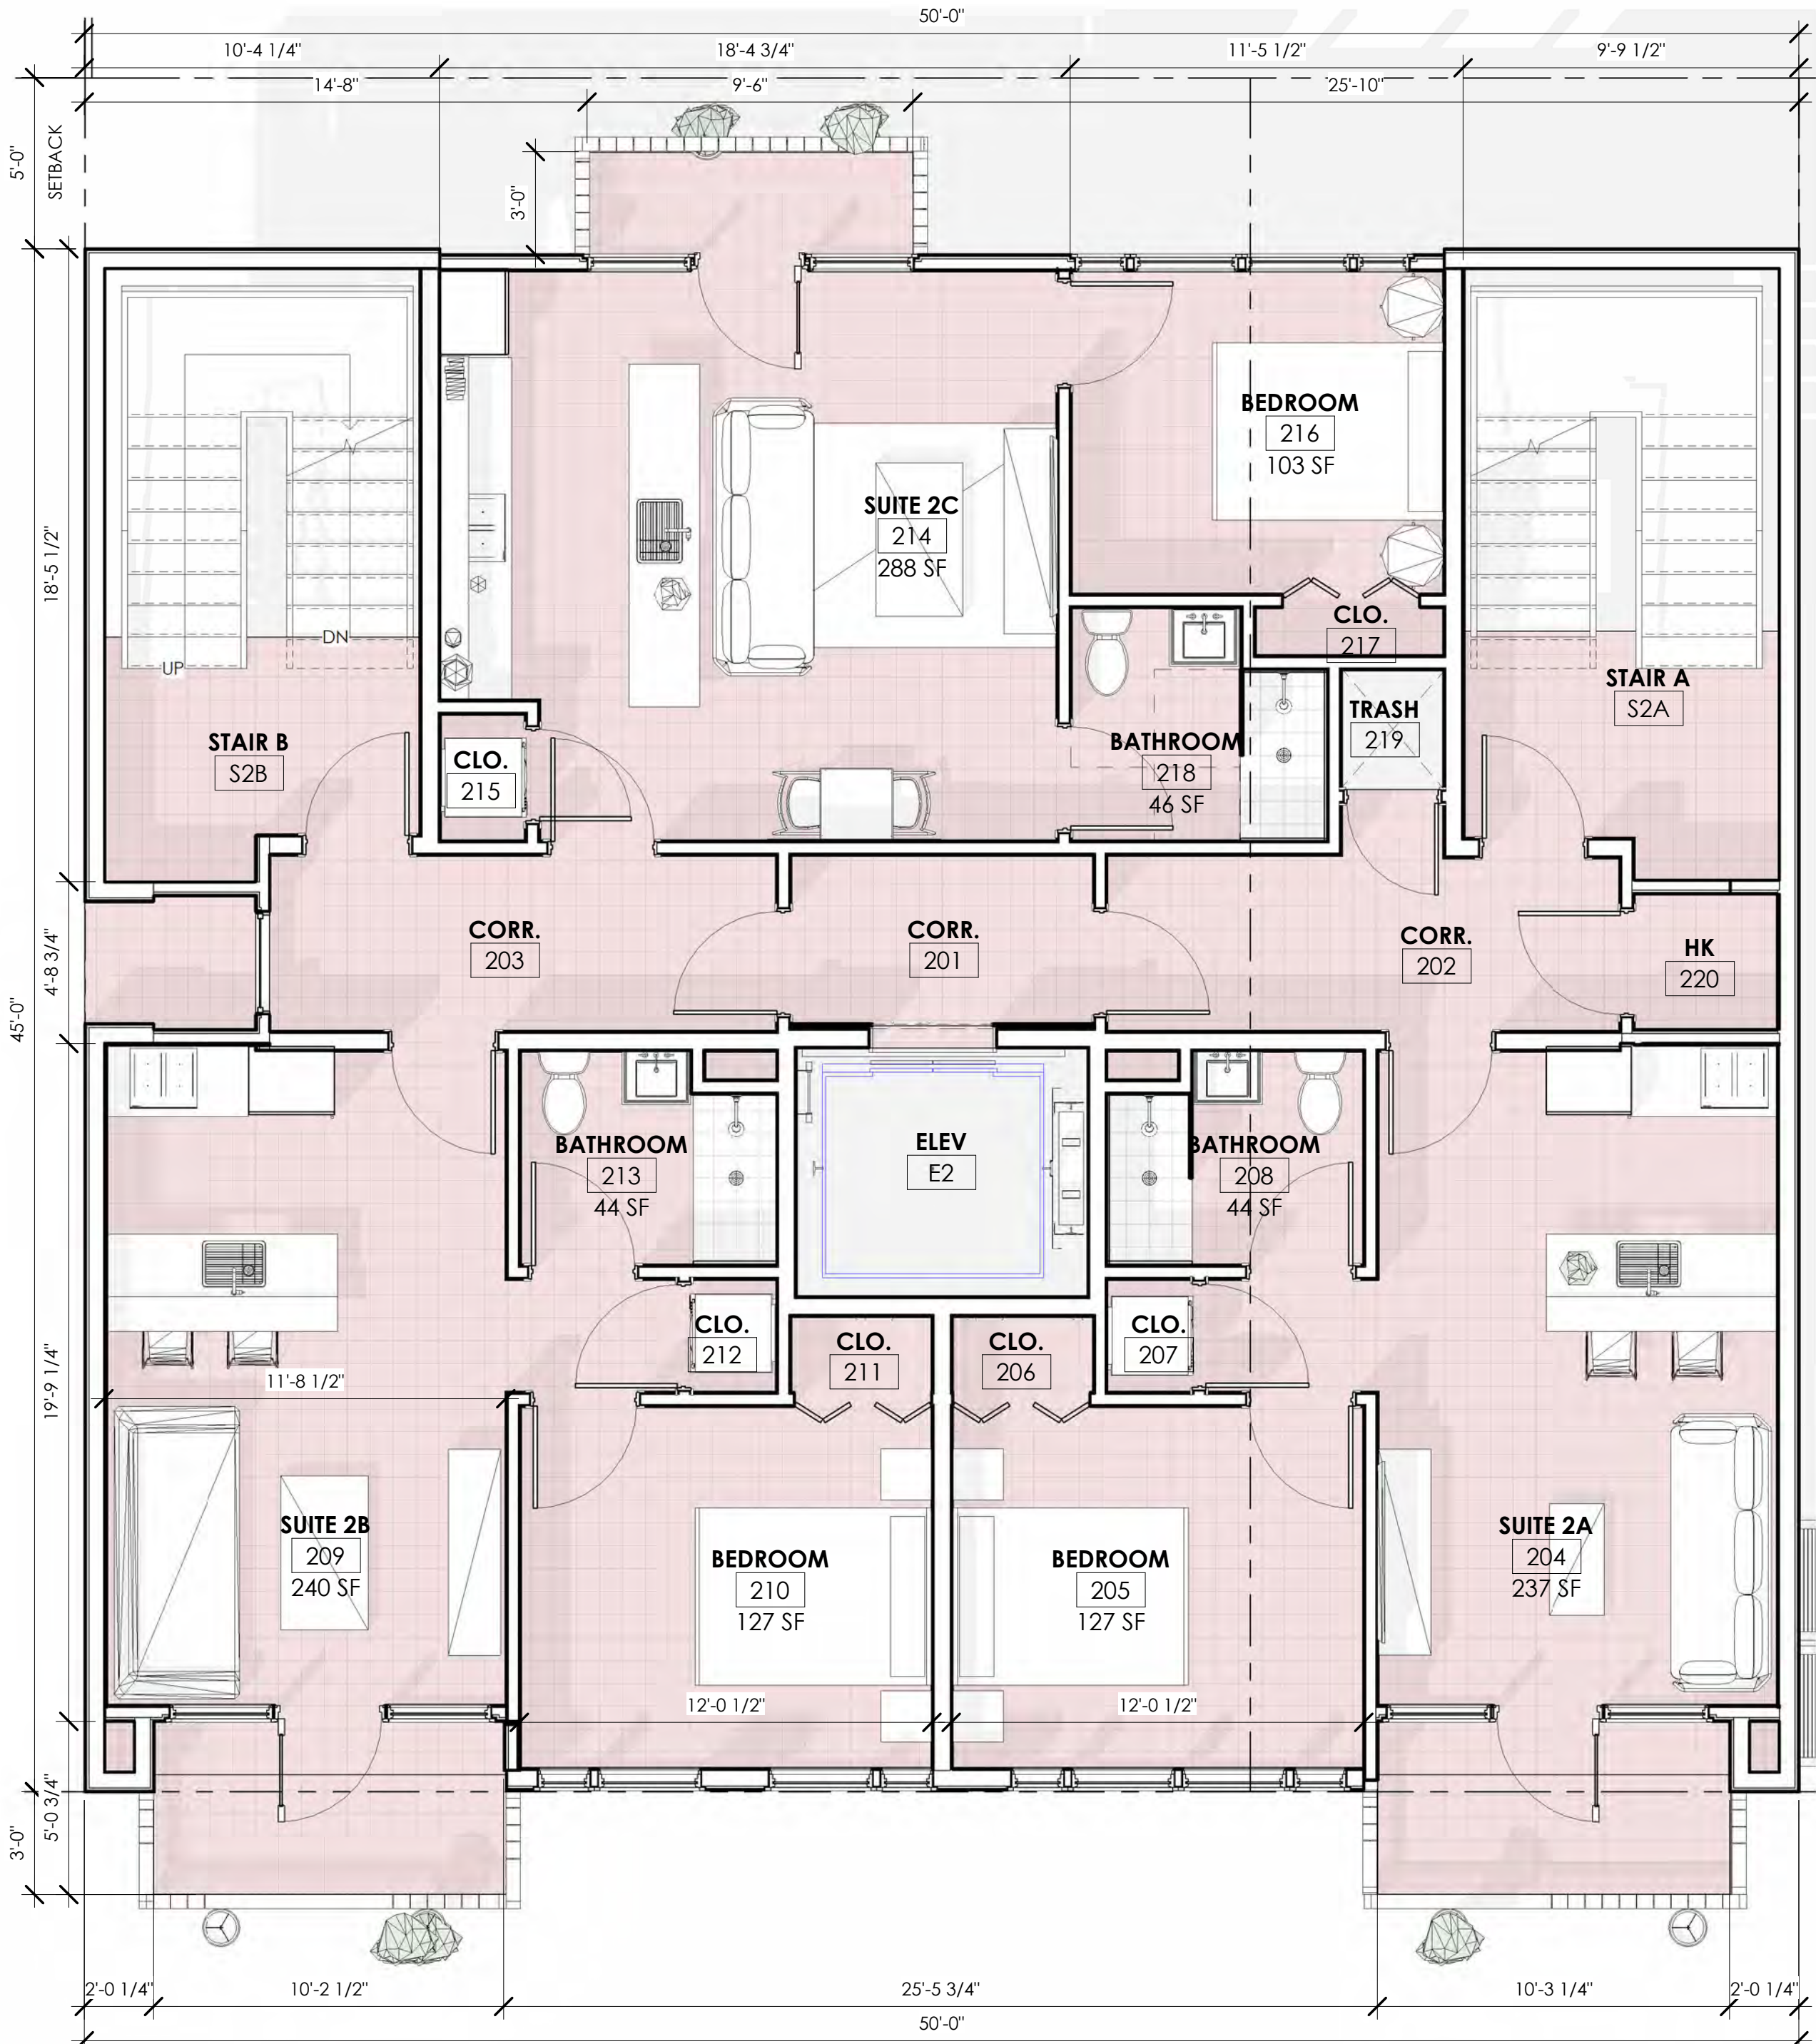
UNIT SCHEDULE				
FLOOR	COMMERCIAL	RESIDENTIAL UNIT TYPE		BED SIZE
		SOUTH FACING (TYPE A)	NORTH FACING (TYPE B)	QUEEN
1	1	0	0	0
2	0	2	1	3
3	0	2	1	3
4	0	2	1	3
5	0	2	1	3
ROOF	0	0	0	0
TOTAL	1	8	4	12

AREA SCHEDULE			
Name	Area	Level	Comments
COMMERCIAL	983 SF	1ST FLOOR	COMMERCIAL
COMMERCIAL: 1	983 SF		
CIRCULATION	177 SF	1ST FLOOR	COMMON
CIRCULATION	336 SF	1ST FLOOR	COMMON
CIRCULATION	159 SF	1ST FLOOR	COMMON
CIRCULATION	668 SF	2ND FLOOR	COMMON
CIRCULATION	668 SF	3RD FLOOR	COMMON
CIRCULATION	668 SF	4TH FLOOR	COMMON
CIRCULATION	668 SF	5TH FLOOR	COMMON
CIRCULATION	410 SF	ROOF	COMMON
ROOF GARDEN	1293 SF	ROOF	COMMON
COMMON: 9	5047 SF		
SUITE 2A	515 SF	2ND FLOOR	RESIDENTIAL
SUITE 2B	515 SF	2ND FLOOR	RESIDENTIAL
SUITE 2C	520 SF	2ND FLOOR	RESIDENTIAL
SUITE 3A	515 SF	3RD FLOOR	RESIDENTIAL
SUITE 3B	515 SF	3RD FLOOR	RESIDENTIAL
SUITE 3C	520 SF	3RD FLOOR	RESIDENTIAL
UNIT 4A	515 SF	4TH FLOOR	RESIDENTIAL
UNIT 4B	515 SF	4TH FLOOR	RESIDENTIAL
UNIT 4C	520 SF	4TH FLOOR	RESIDENTIAL
SUITE 5A	515 SF	5TH FLOOR	RESIDENTIAL
SUITE 5B	515 SF	5TH FLOOR	RESIDENTIAL
SUITE 5C	520 SF	5TH FLOOR	RESIDENTIAL
RESIDENTIAL: 12	6198 SF		
UTILITIES	283 SF	1ST FLOOR	SERVICE
MECHANICAL	402 SF	ROOF	SERVICE
SERVICE: 2	684 SF		
Grand total: 24	12914 SF		




1 1ST FLR PLAN
1/4" = 1'-0"

TENNESSEE AVENUE (50' R.O.W.)

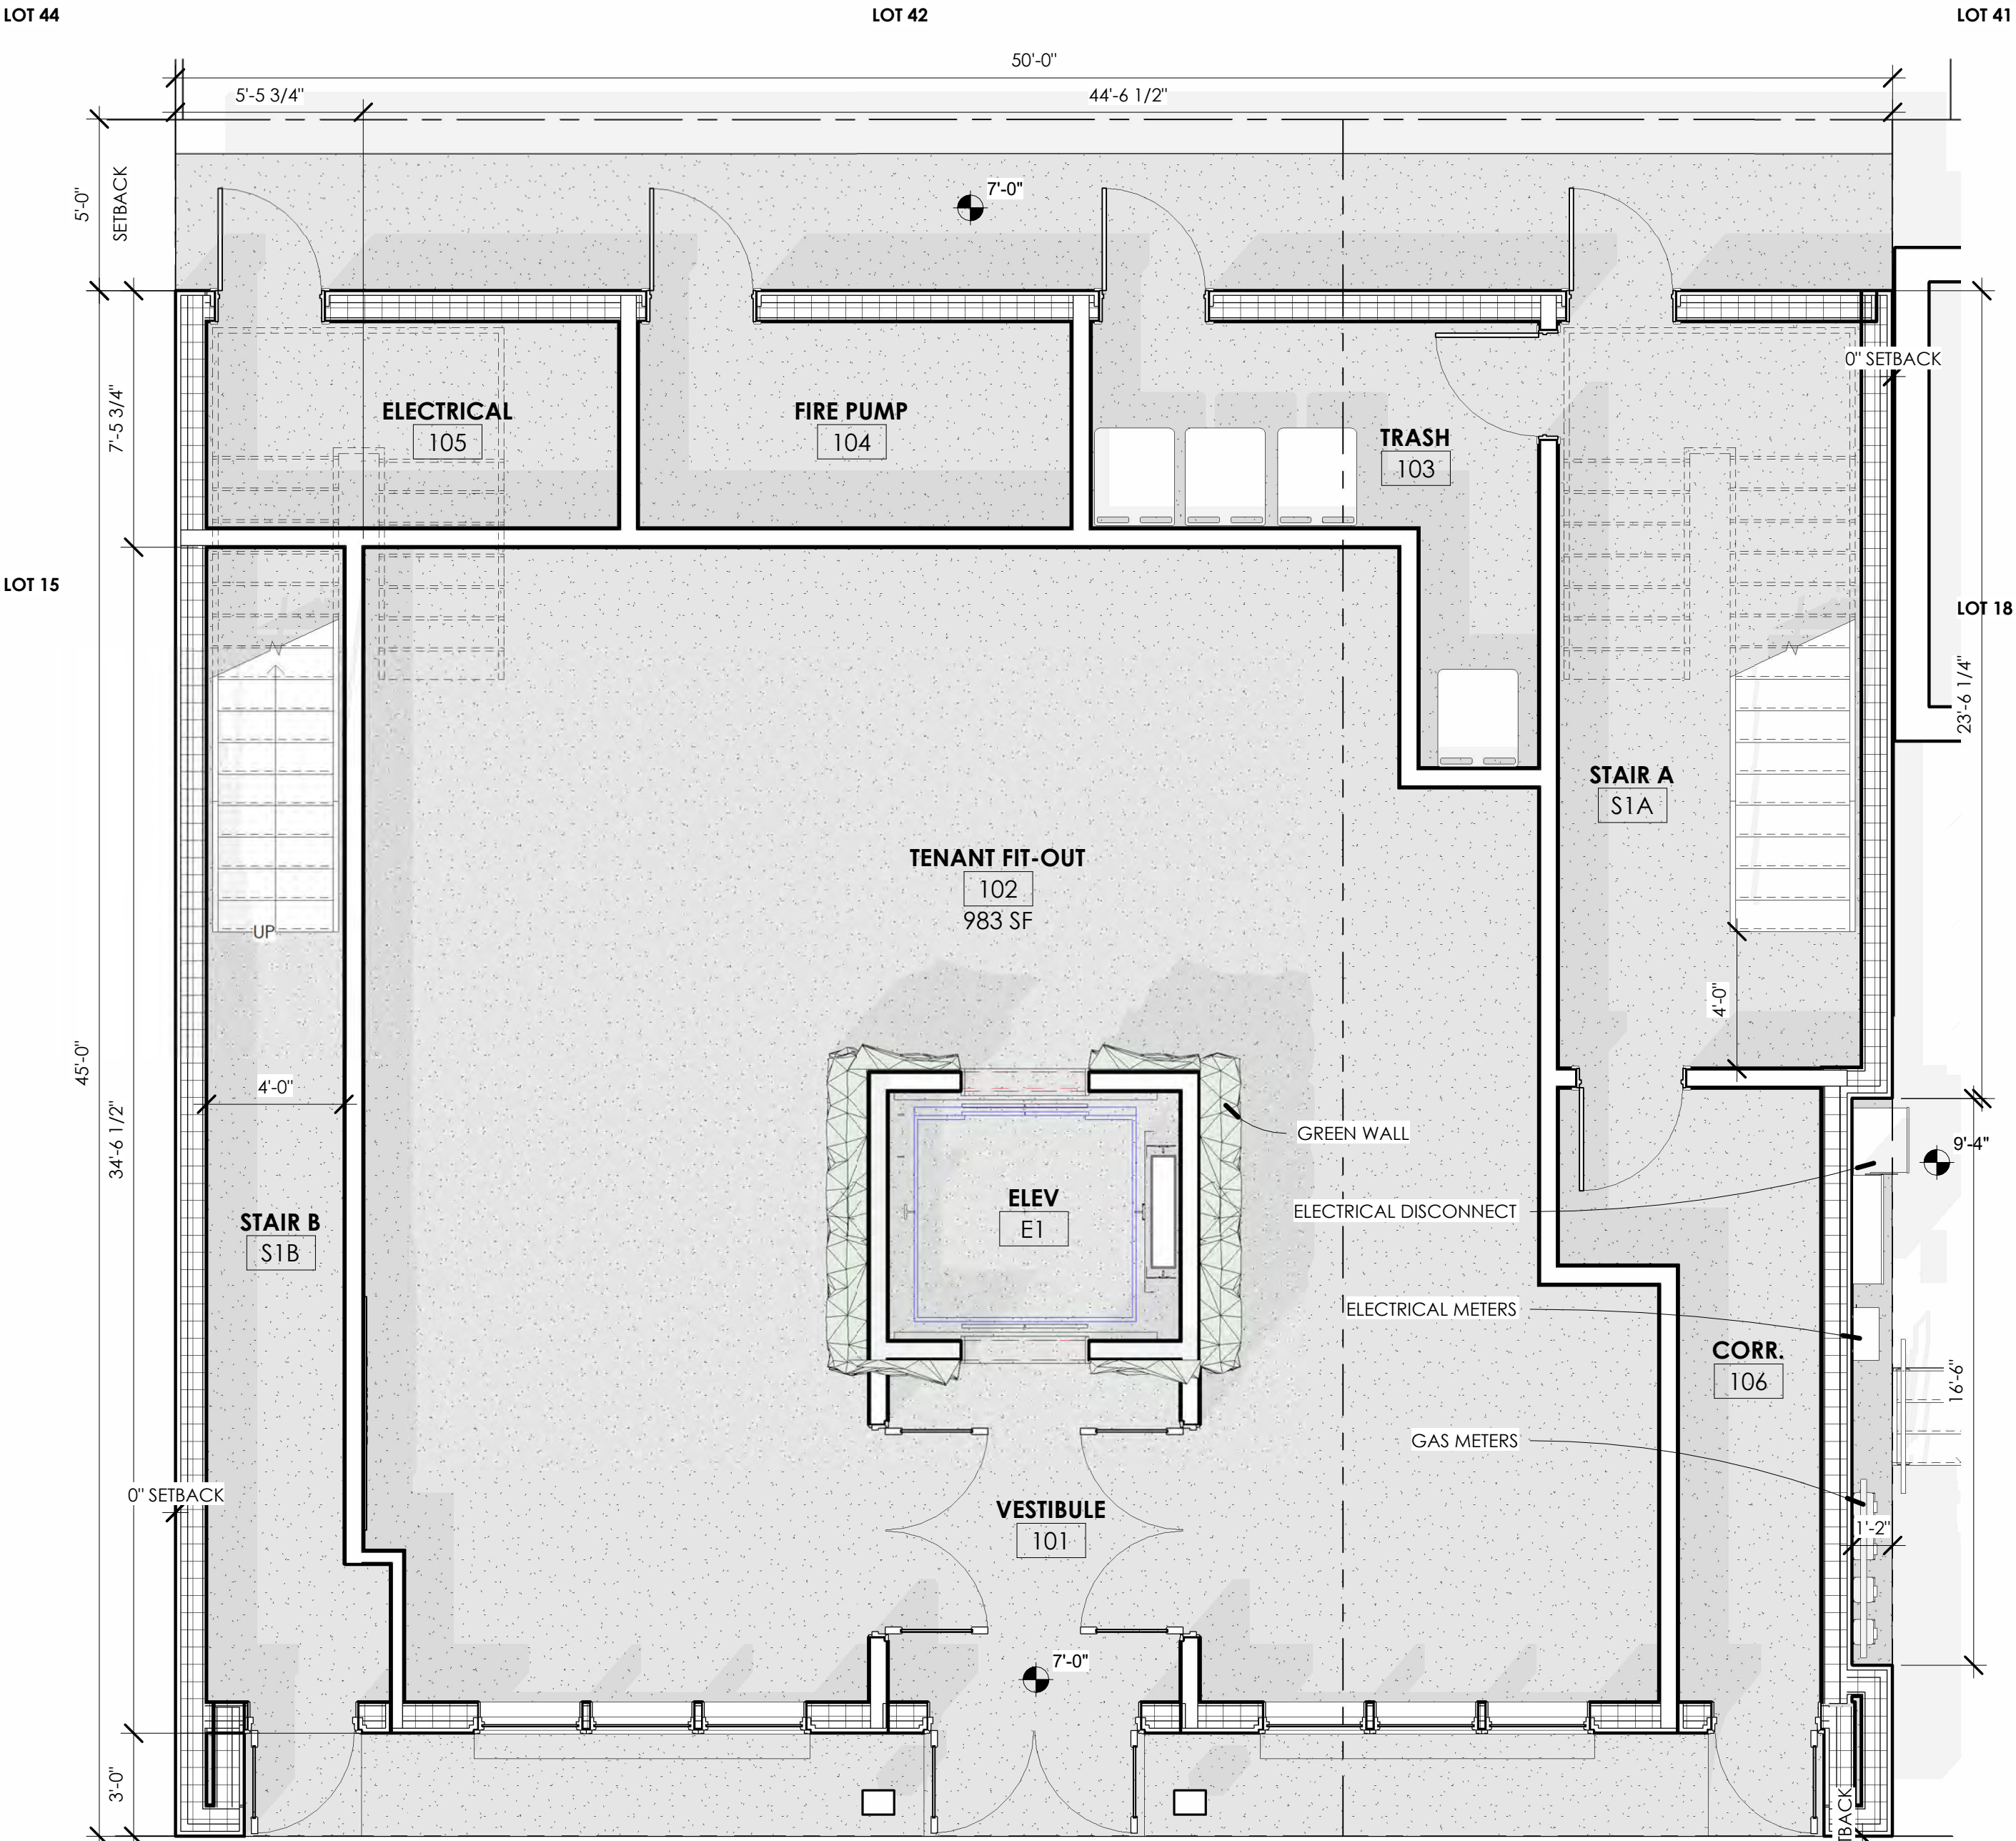

2 2ND FLR PLAN
1/4" = 1'-0"

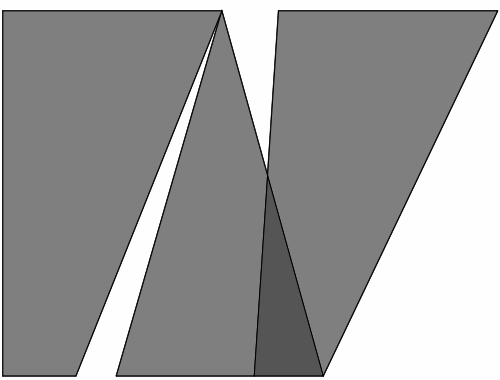

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**NEW CONSTRUCTION
SURF LODGE**

**BLOCK 54, LOTS 16 & 17
ATLANTIC CITY, NJ 08401**


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1	CRDA REVISION	10.11.22

**FLOOR PLANS - 3RD &
4TH FLOOR**


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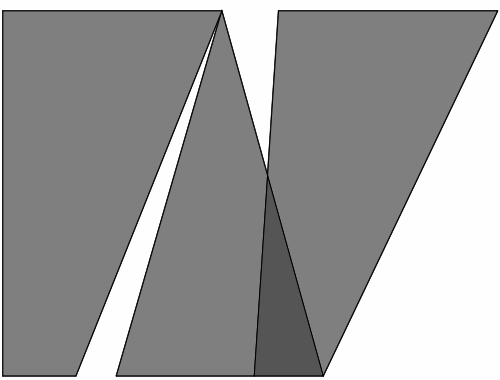
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2 4TH FLOOR
1/4" = 1'-0"



1 3RD FLR PLAN
1/4" = 1'-0"

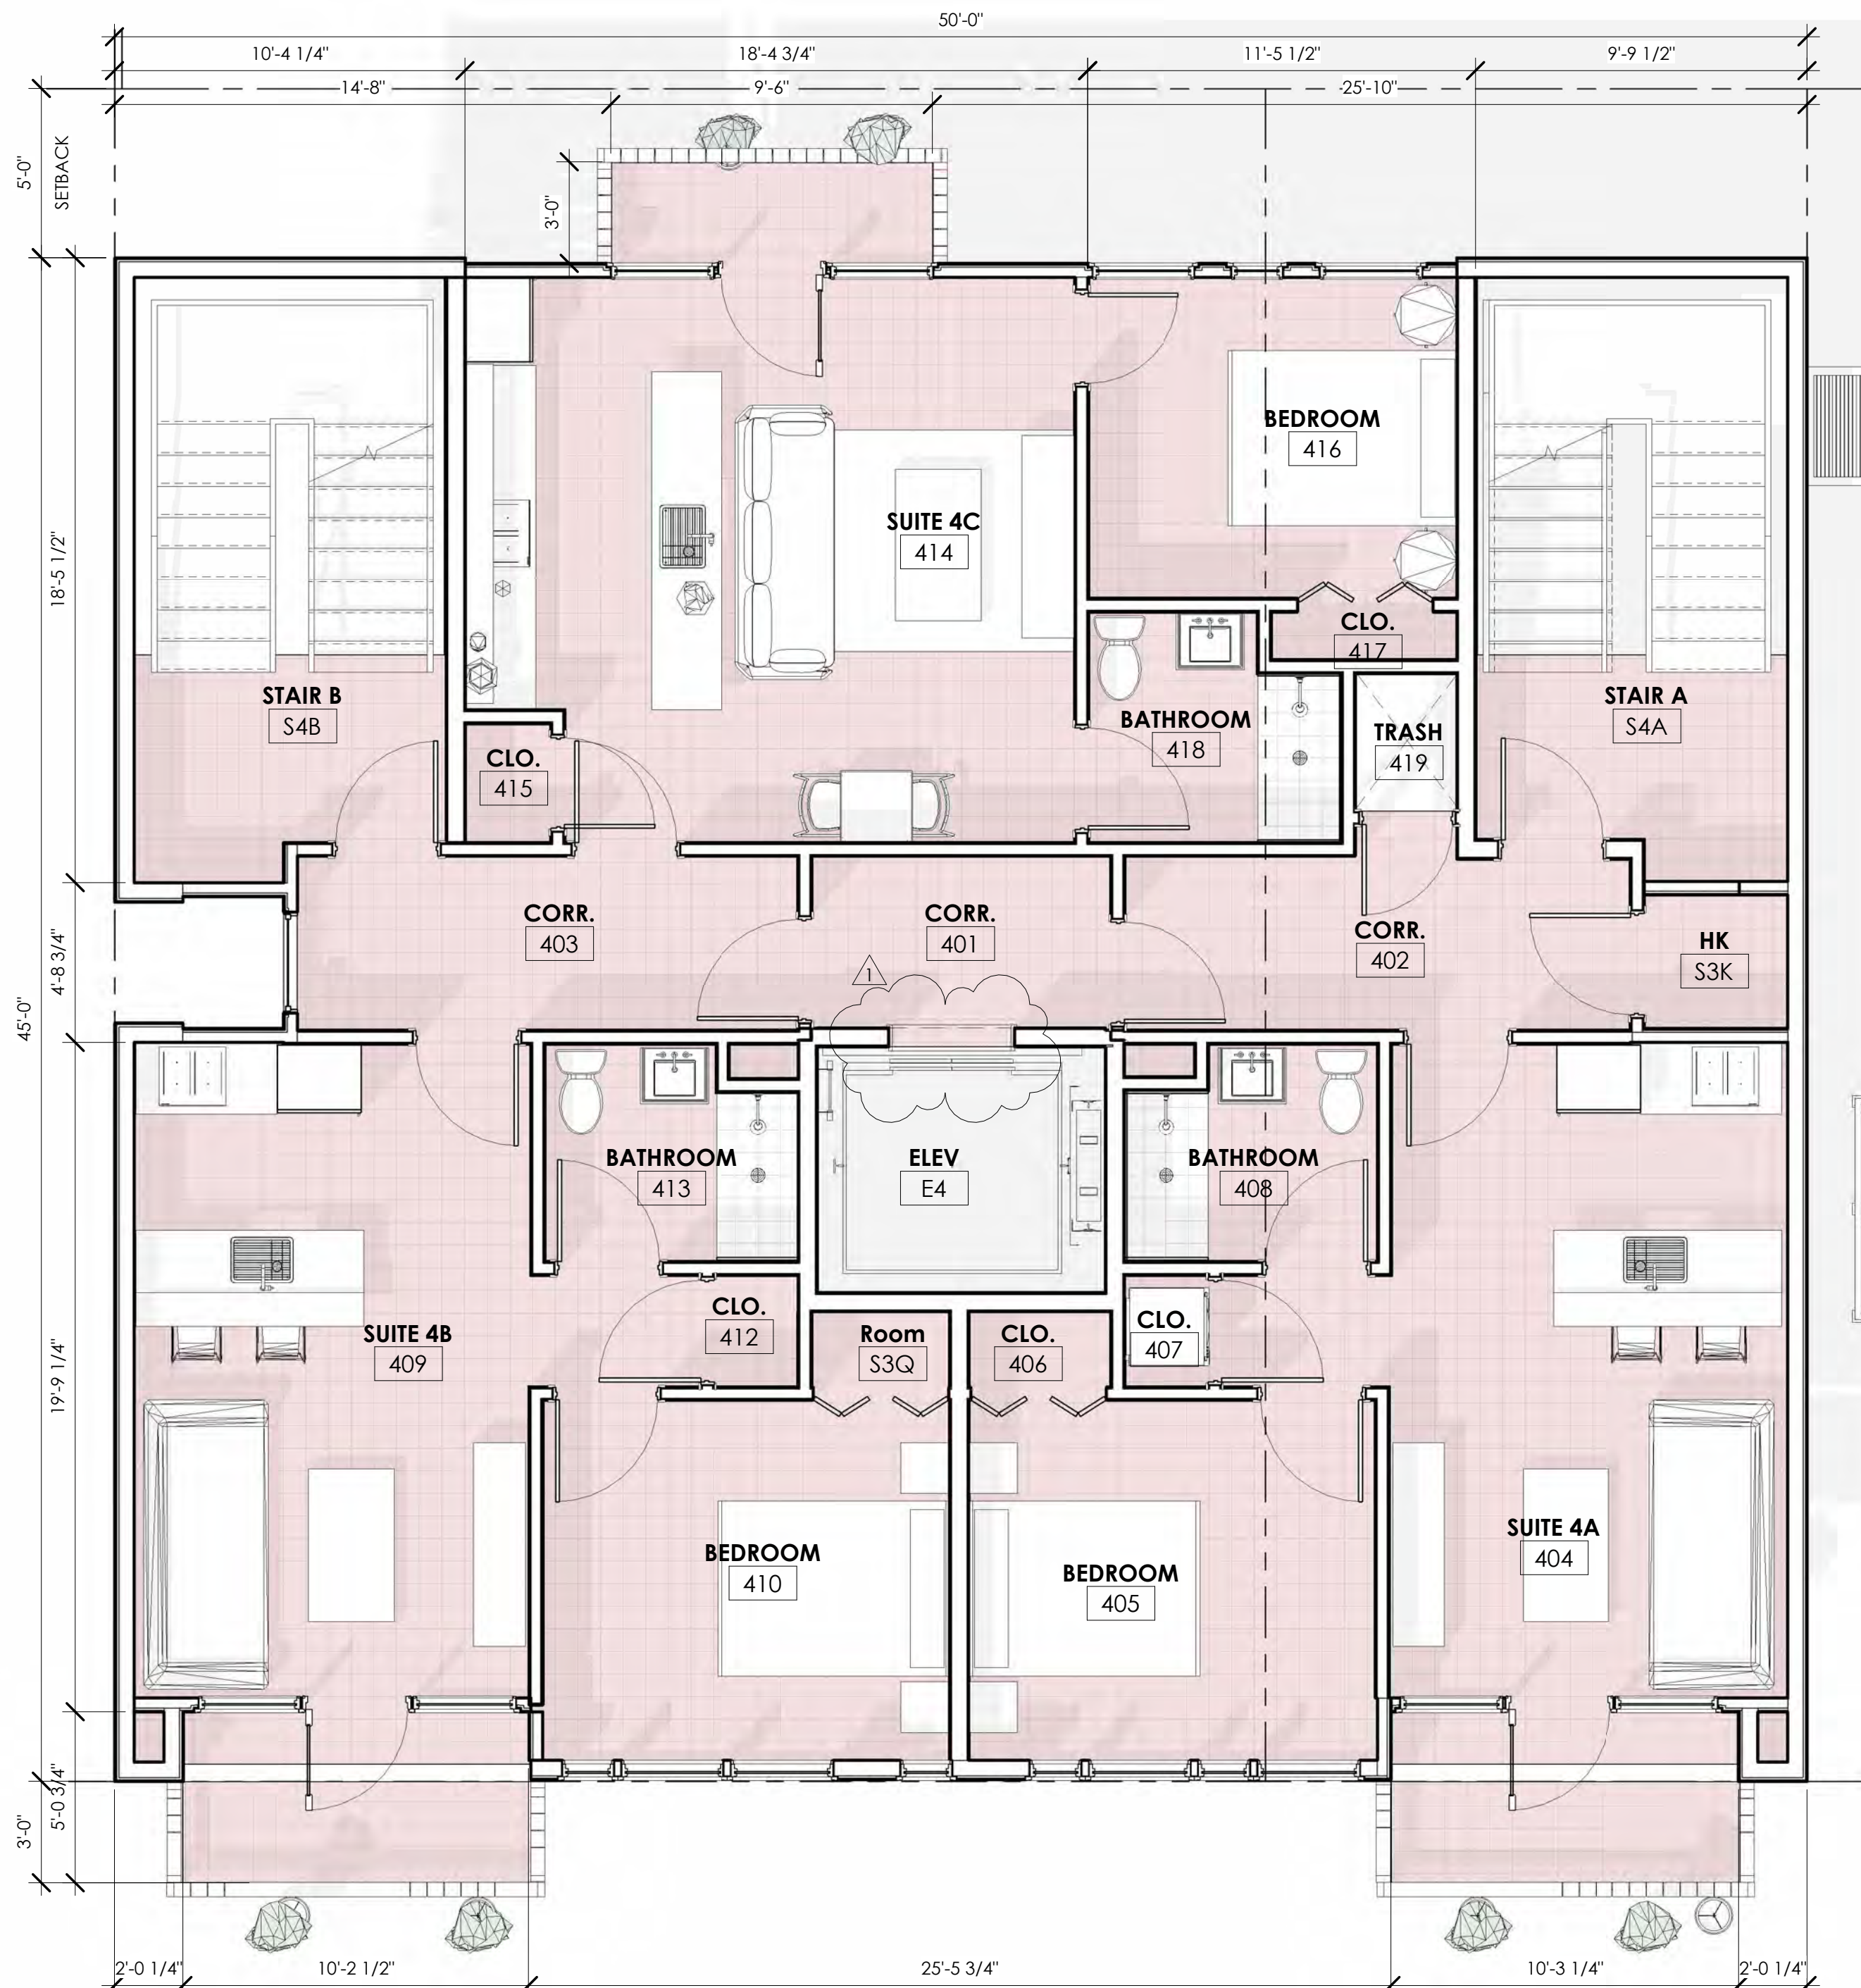

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NEW CONSTRUCTION
SURF LODGE

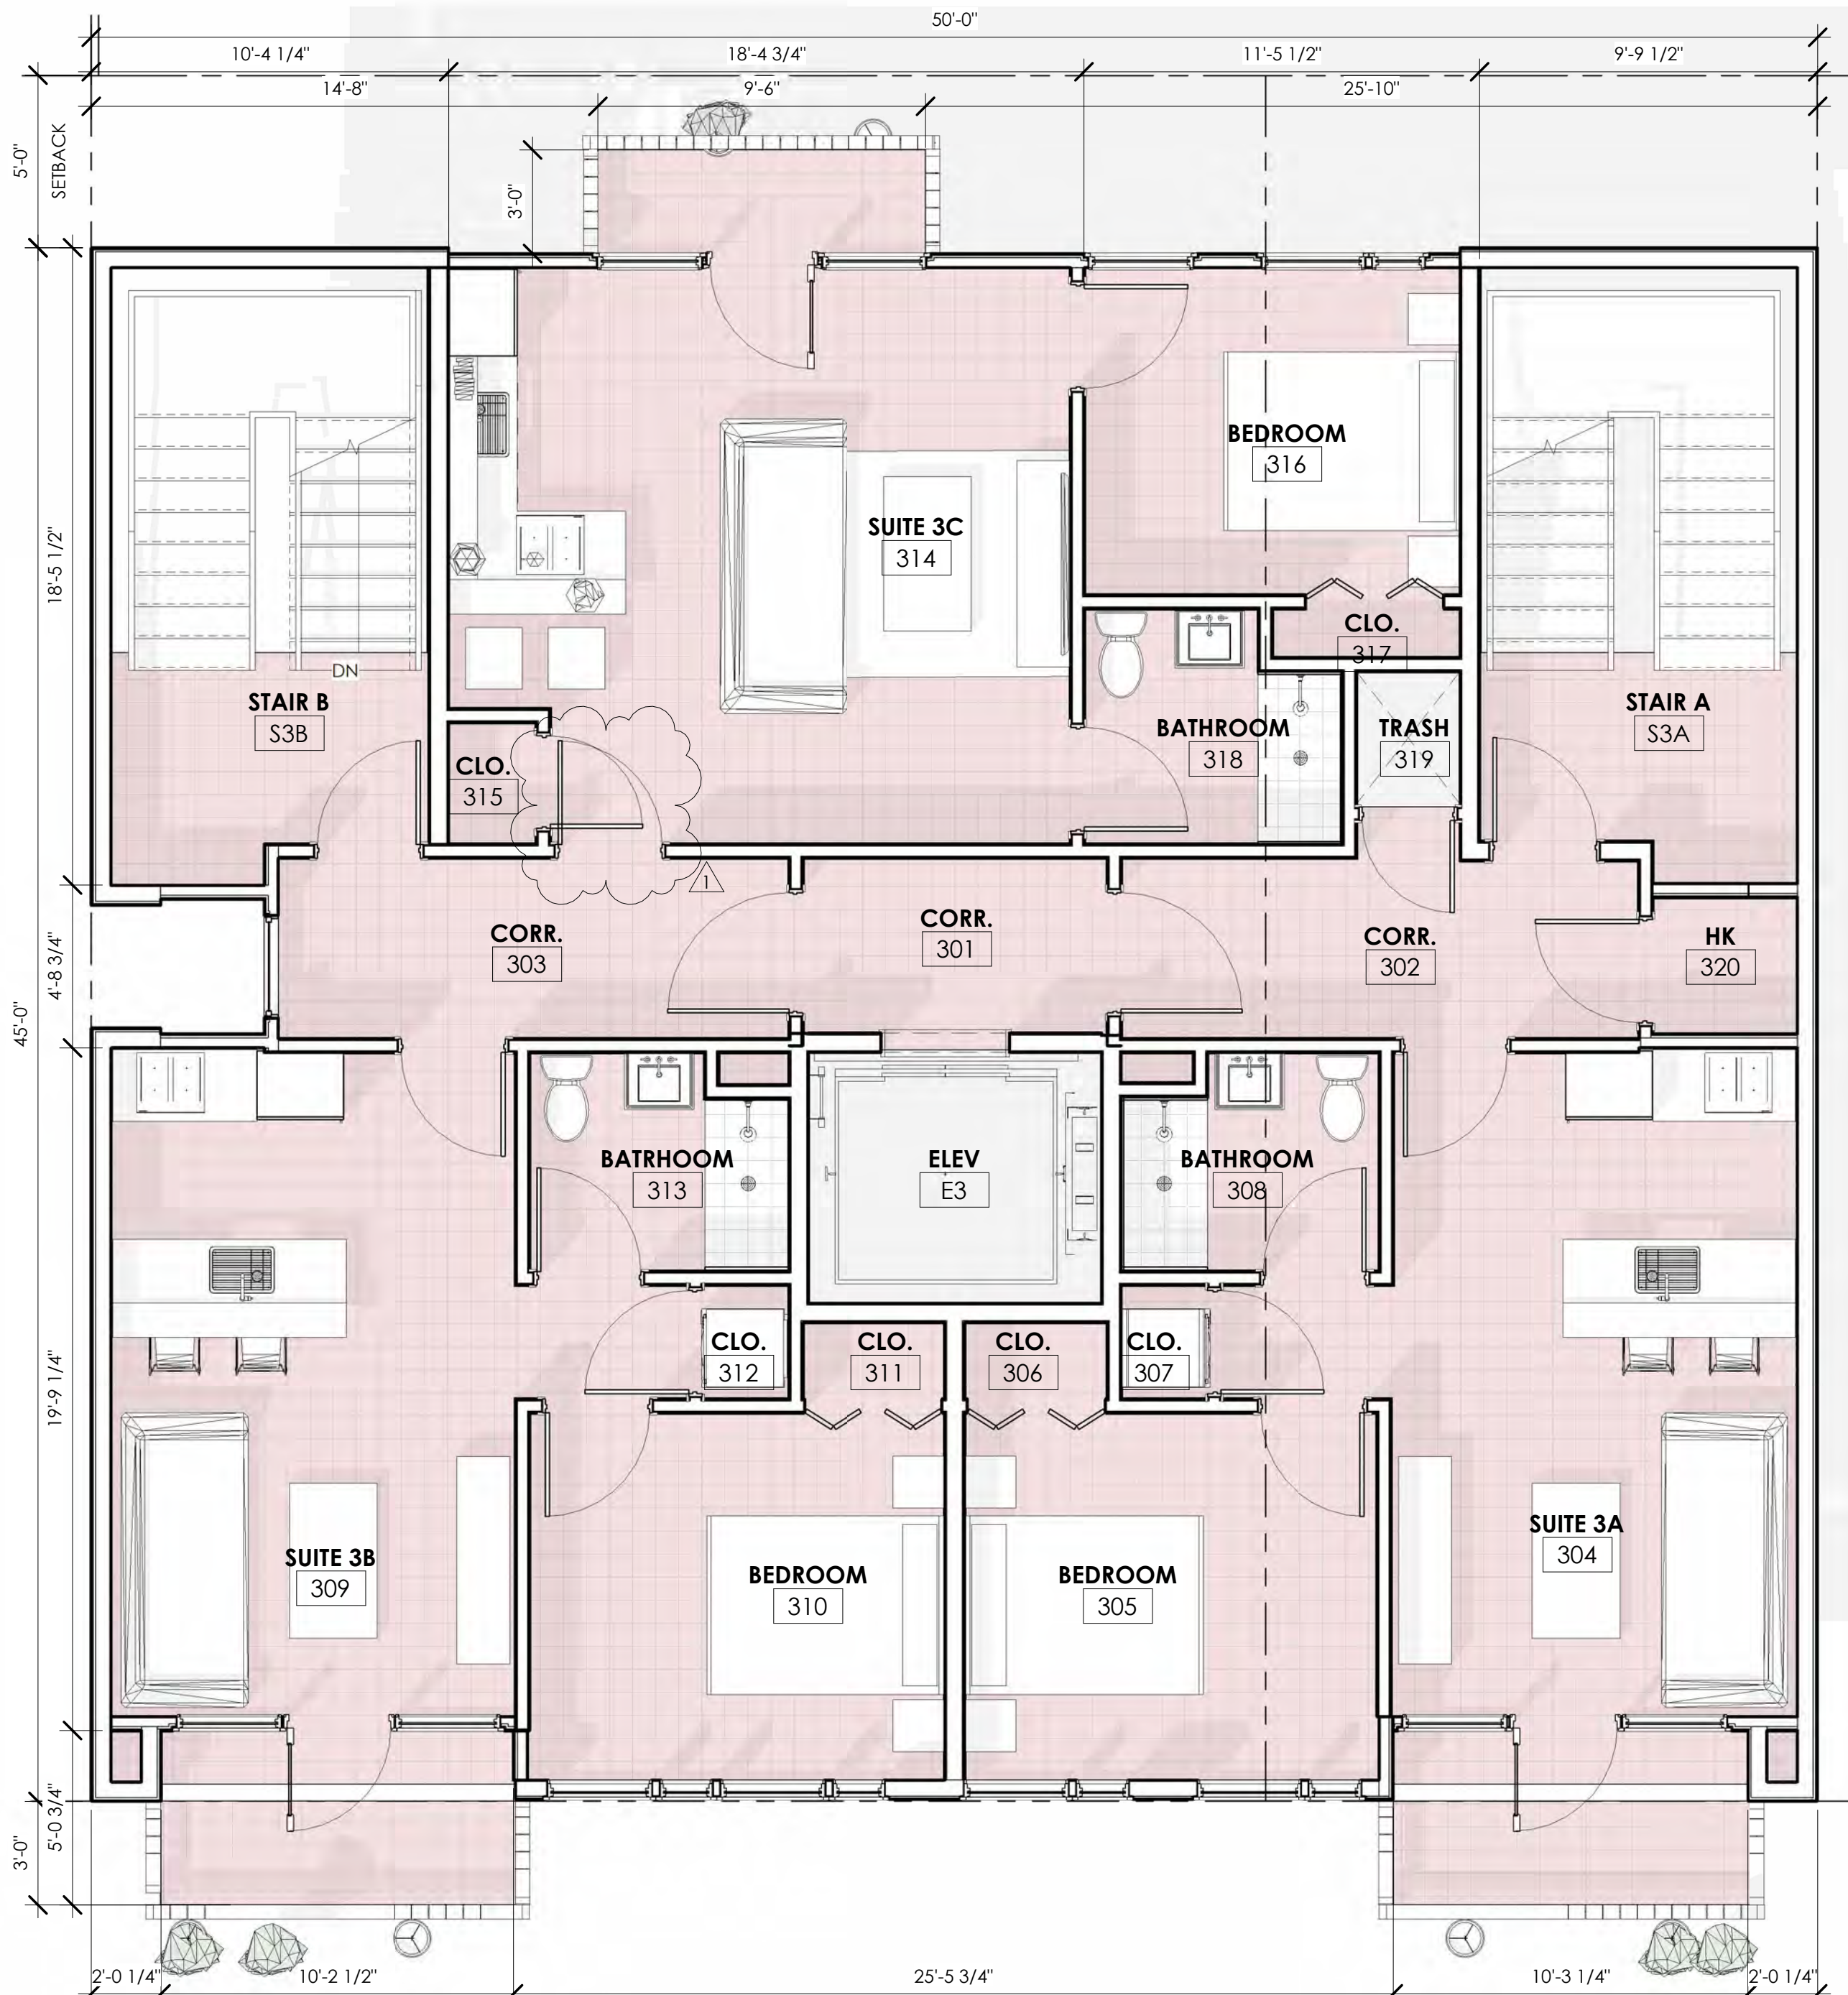BLOCK 54, LOTS 16 & 17
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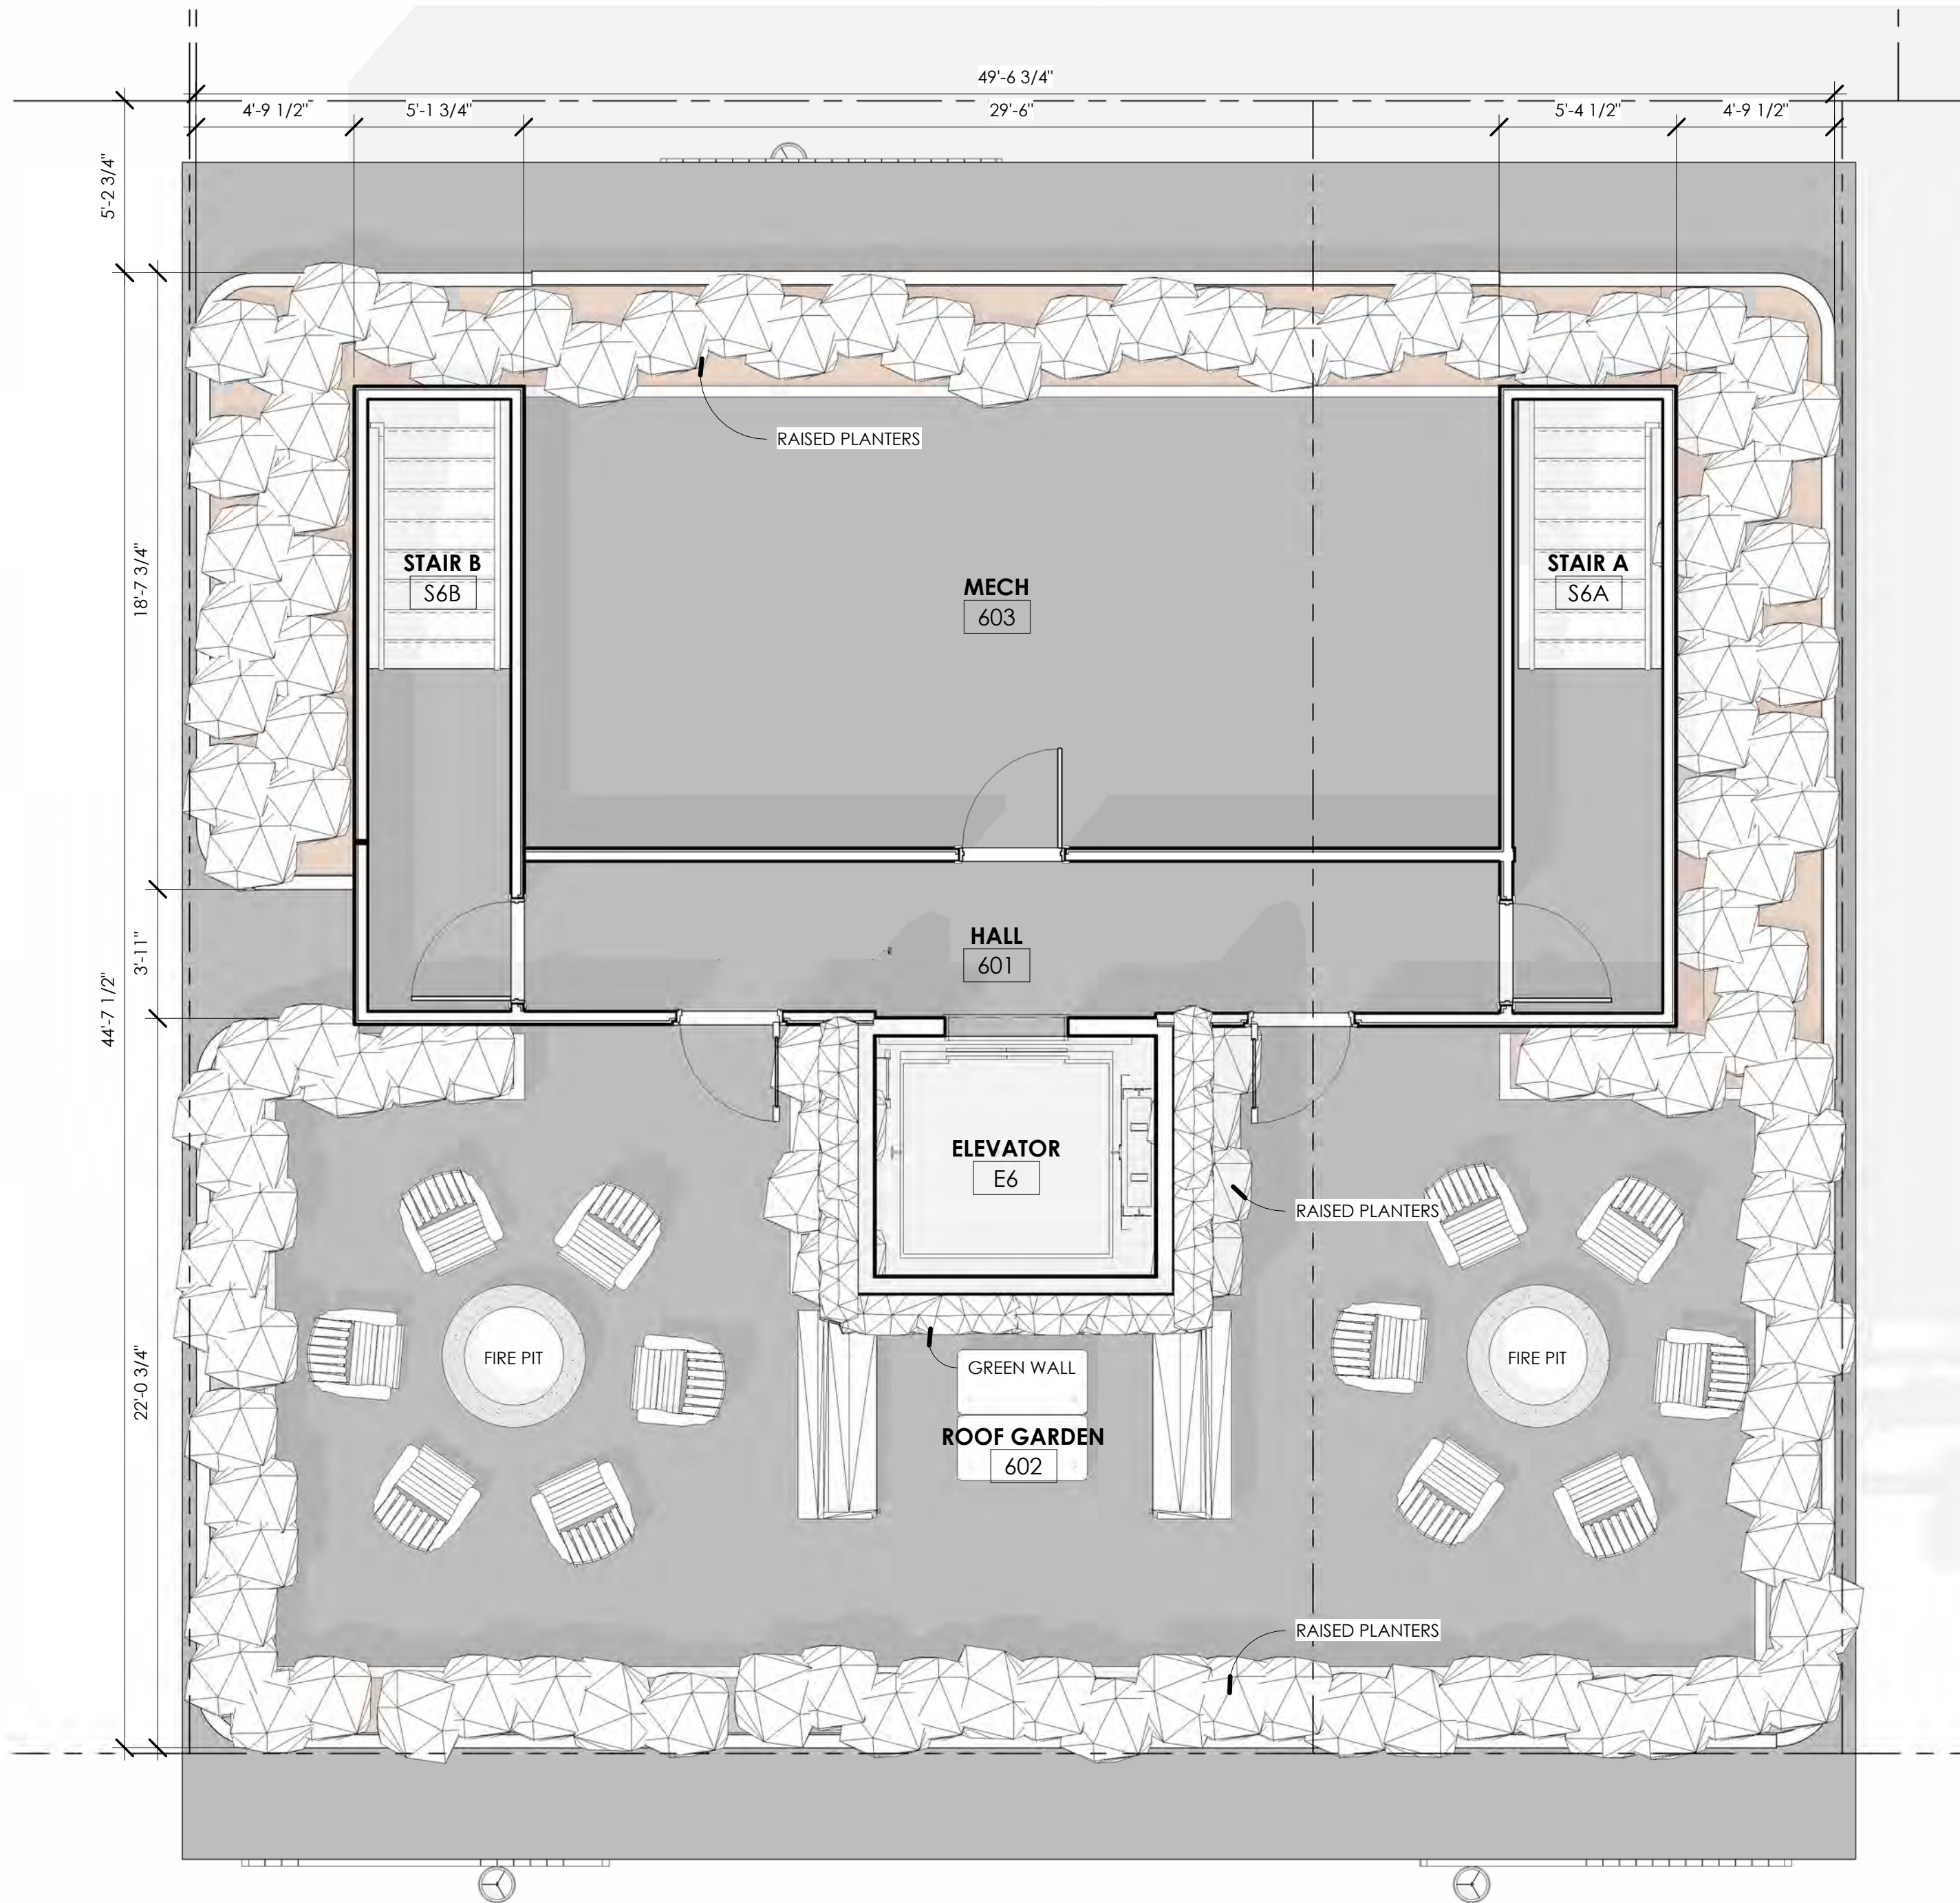
No.	Description	Date

FLOOR PLANS - 5TH
FLOOR & ROOF


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Comission no. 21086S



2 ROOF
1/4" = 1'-0"



1 5TH FLOOR
1/4" = 1'-0"

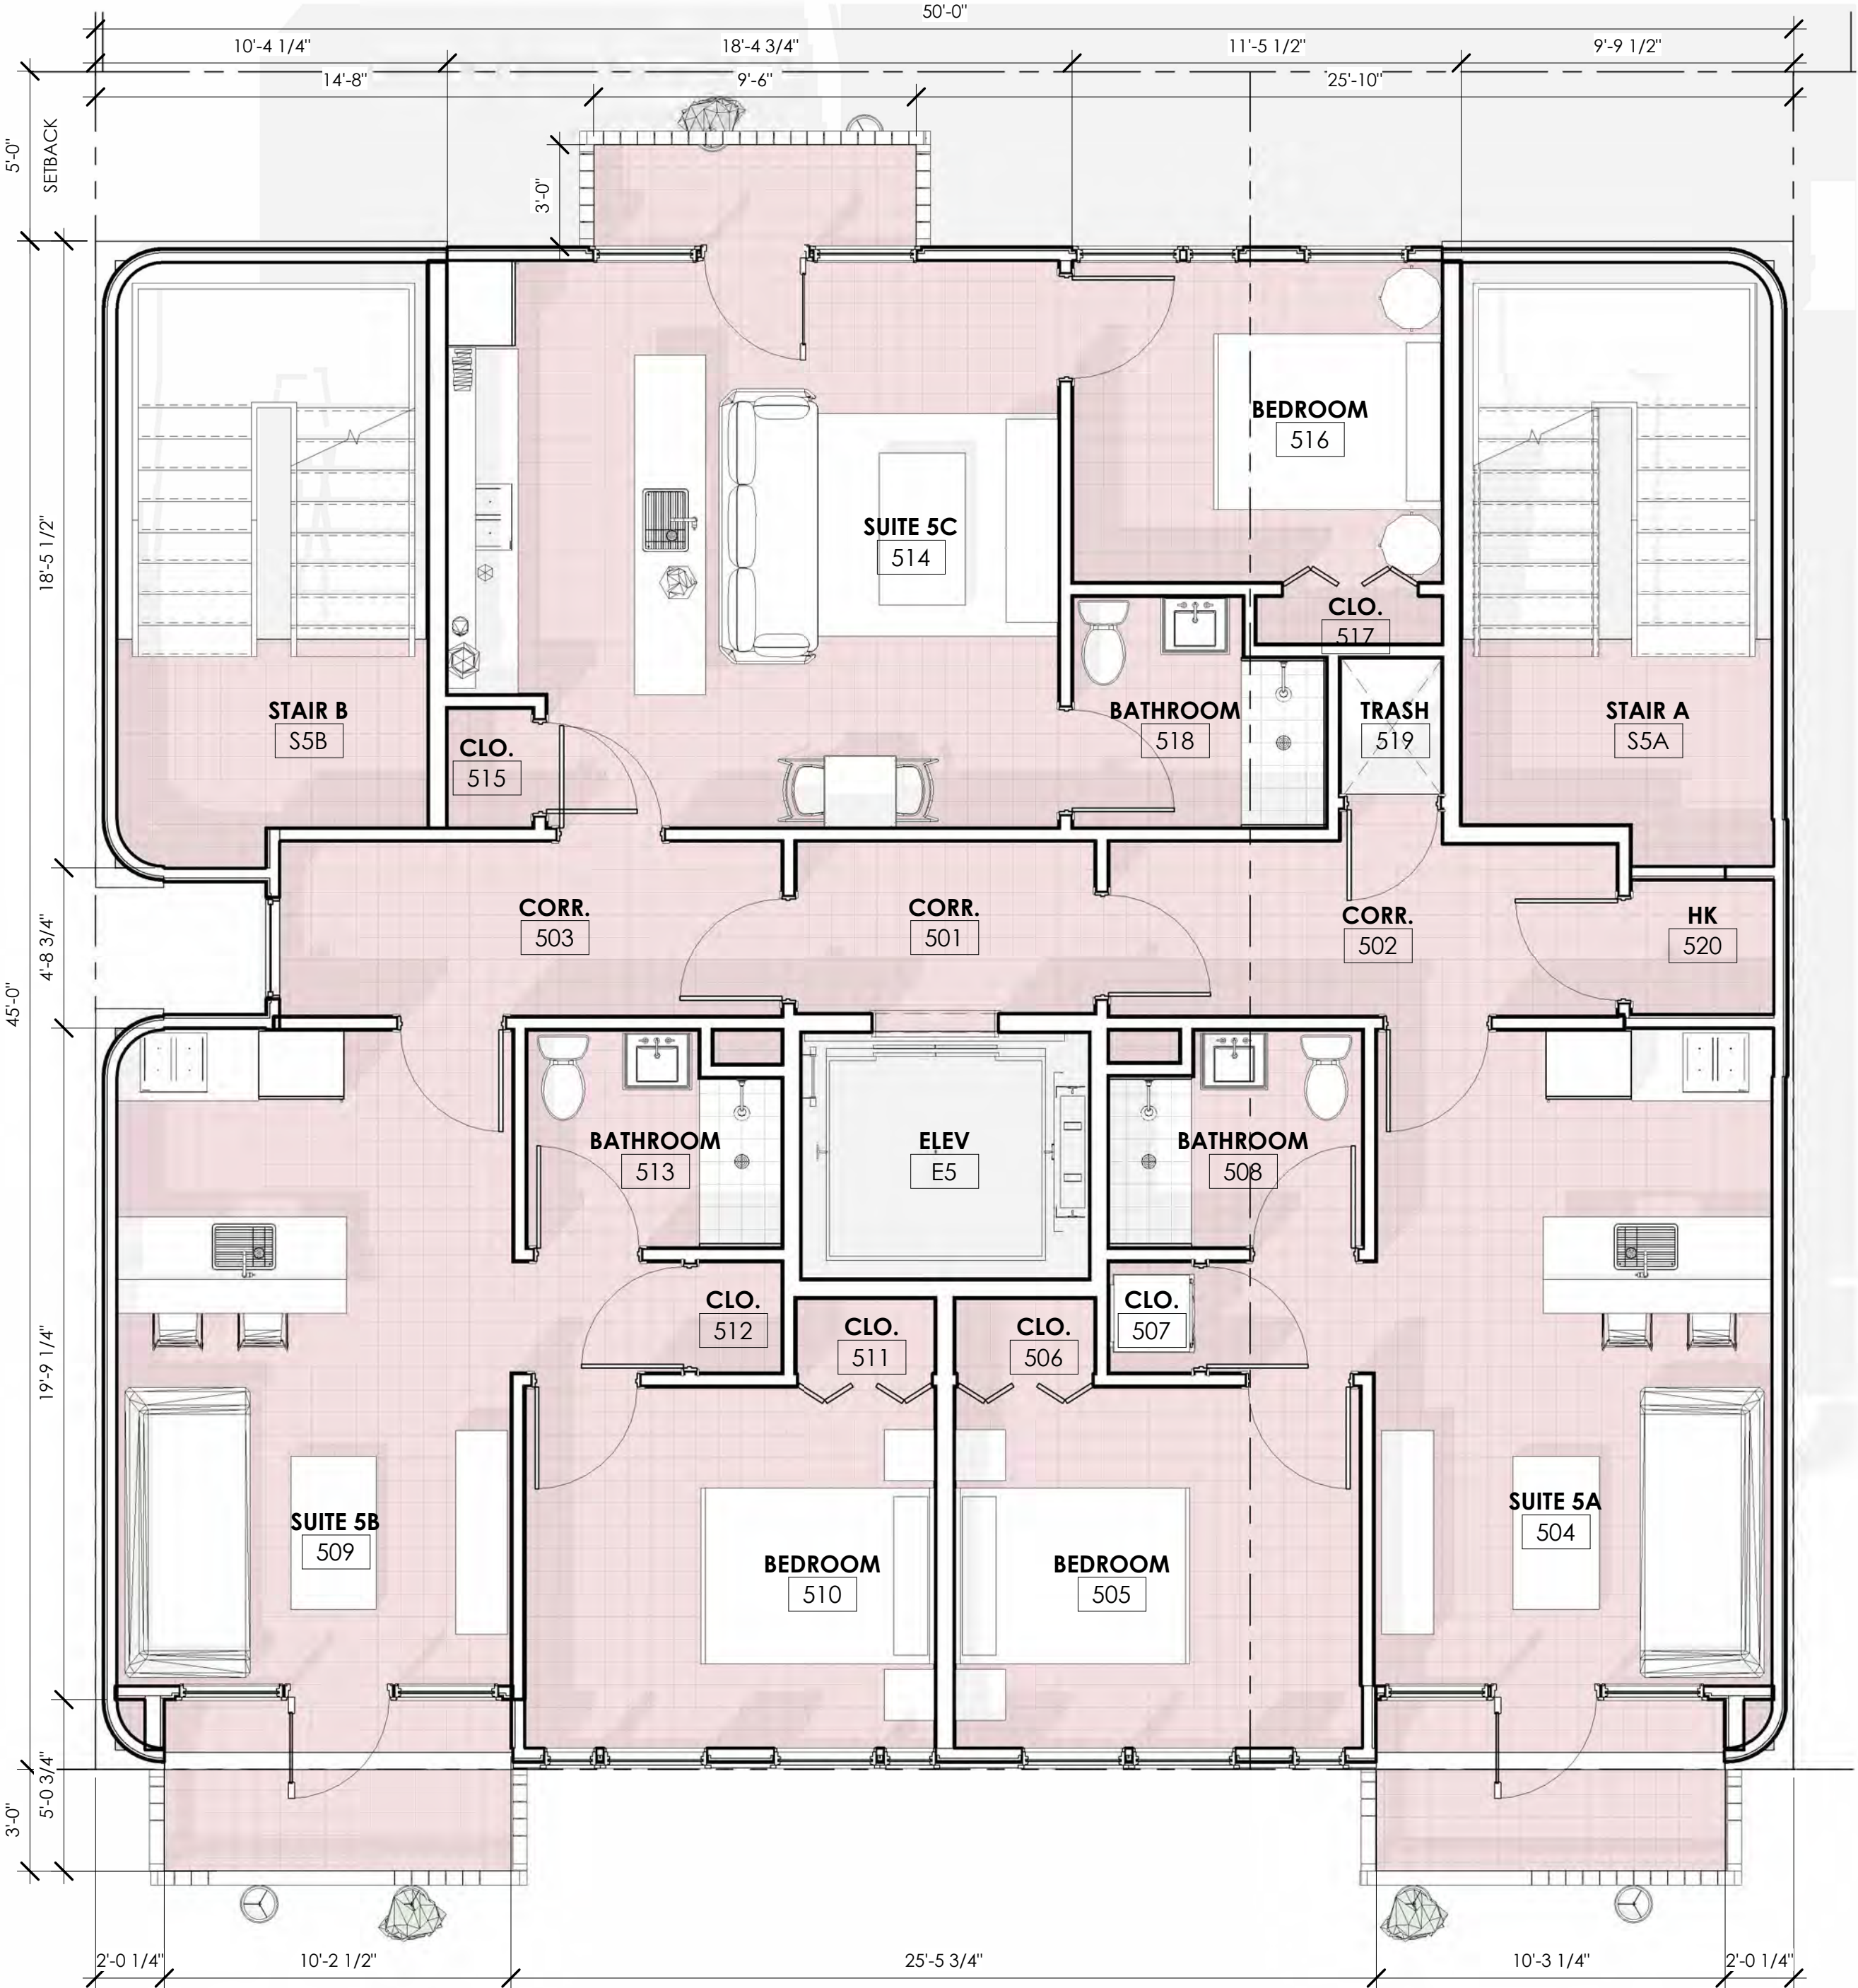
EXTERIOR FINISH SCHEDULE	
KEY VALUE	TEXT
CON10	CONCRETE
DR10	MARVIN ULTIMATE SINGLE OUTSWING DOOR; COLOR BY ARCHITECT.
DR20	MARVIN ULTIMATE DOUBLE OUTSWING DOOR; COLOR BY ARCHITECT.
GW10	VERTICAL GREENWALL; DESIGN BY ARCHITECT.
OH10	WOOD & PAINTED METAL WIRE SCREEN OVERHANG; COLOR BY ARCHITECT.
PB10	RAISED PLANTING BED.
RL10	WOOD POSTS & RAILINGS W/ PAINTED METAL WIRE OVERHANG; COLOR BY ARCHITECT.
WD10	WOOD PANEL FINISH; COLOR & DESIGN BY ARCHITECT.
WW10	MARVIN ULTIMATE DIRECT GLAZE WINDOW; COLOR BY ARCHITECT.



2 NORTH ELEVATION
3/16" = 1'-0"



1 SOUTH ELEVATION
3/16" = 1'-0"

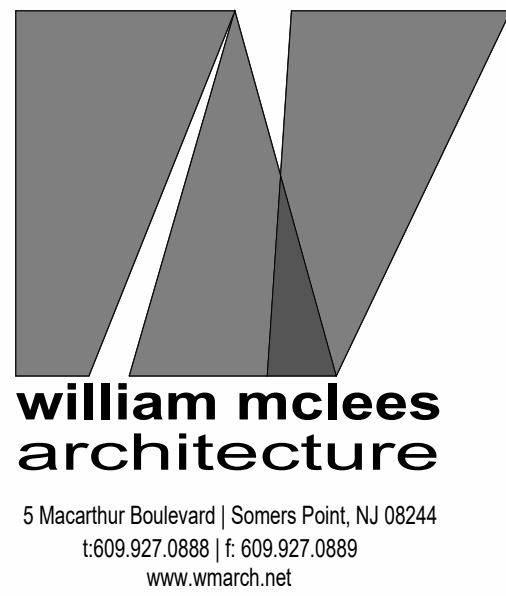

William C. McLees
AIA, LEED AP
New Jersey State License AI 14054
Pennsylvania State License RA403479



William McLees Architecture, LLC
New Jersey State Certificate of Authorization # 21AC0055500

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NEW CONSTRUCTION SURF LODGE

BLOCK 54, LOTS 16 & 17
ATLANTIC CITY, NJ 08401

No.	Description	Date


ELEVATIONS

Scale 3/16" = 1'-0"
Drawn by WSZ
Date 10.05.22


A2.01

Comission no. 210865


EXTERIOR FINISH SCHEDULE	
KEY VALUE	TEXT
CON10	CONCRETE
DR10	MARVIN ULTIMATE SINGLE OUTSWING DOOR; COLOR BY ARCHITECT.
DR20	MARVIN ULTIMATE DOUBLE OUTSWING DOOR; COLOR BY ARCHITECT.
GW10	VERTICAL GREENWALL; DESIGN BY ARCHITECT.
OH10	WOOD & PAINTED METAL WIRE SCREEN OVERHANG; COLOR BY ARCHITECT.
PB10	RAISED PLANTING BED.
RL10	WOOD POSTS & RAILINGS W/ PAINTED METAL WIRE OVERHANG; COLOR BY ARCHITECT.
WD10	WOOD PANEL FINISH; COLOR & DESIGN BY ARCHITECT.
WW10	MARVIN ULTIMATE DIRECT GLAZE WINDOW; COLOR BY ARCHITECT.

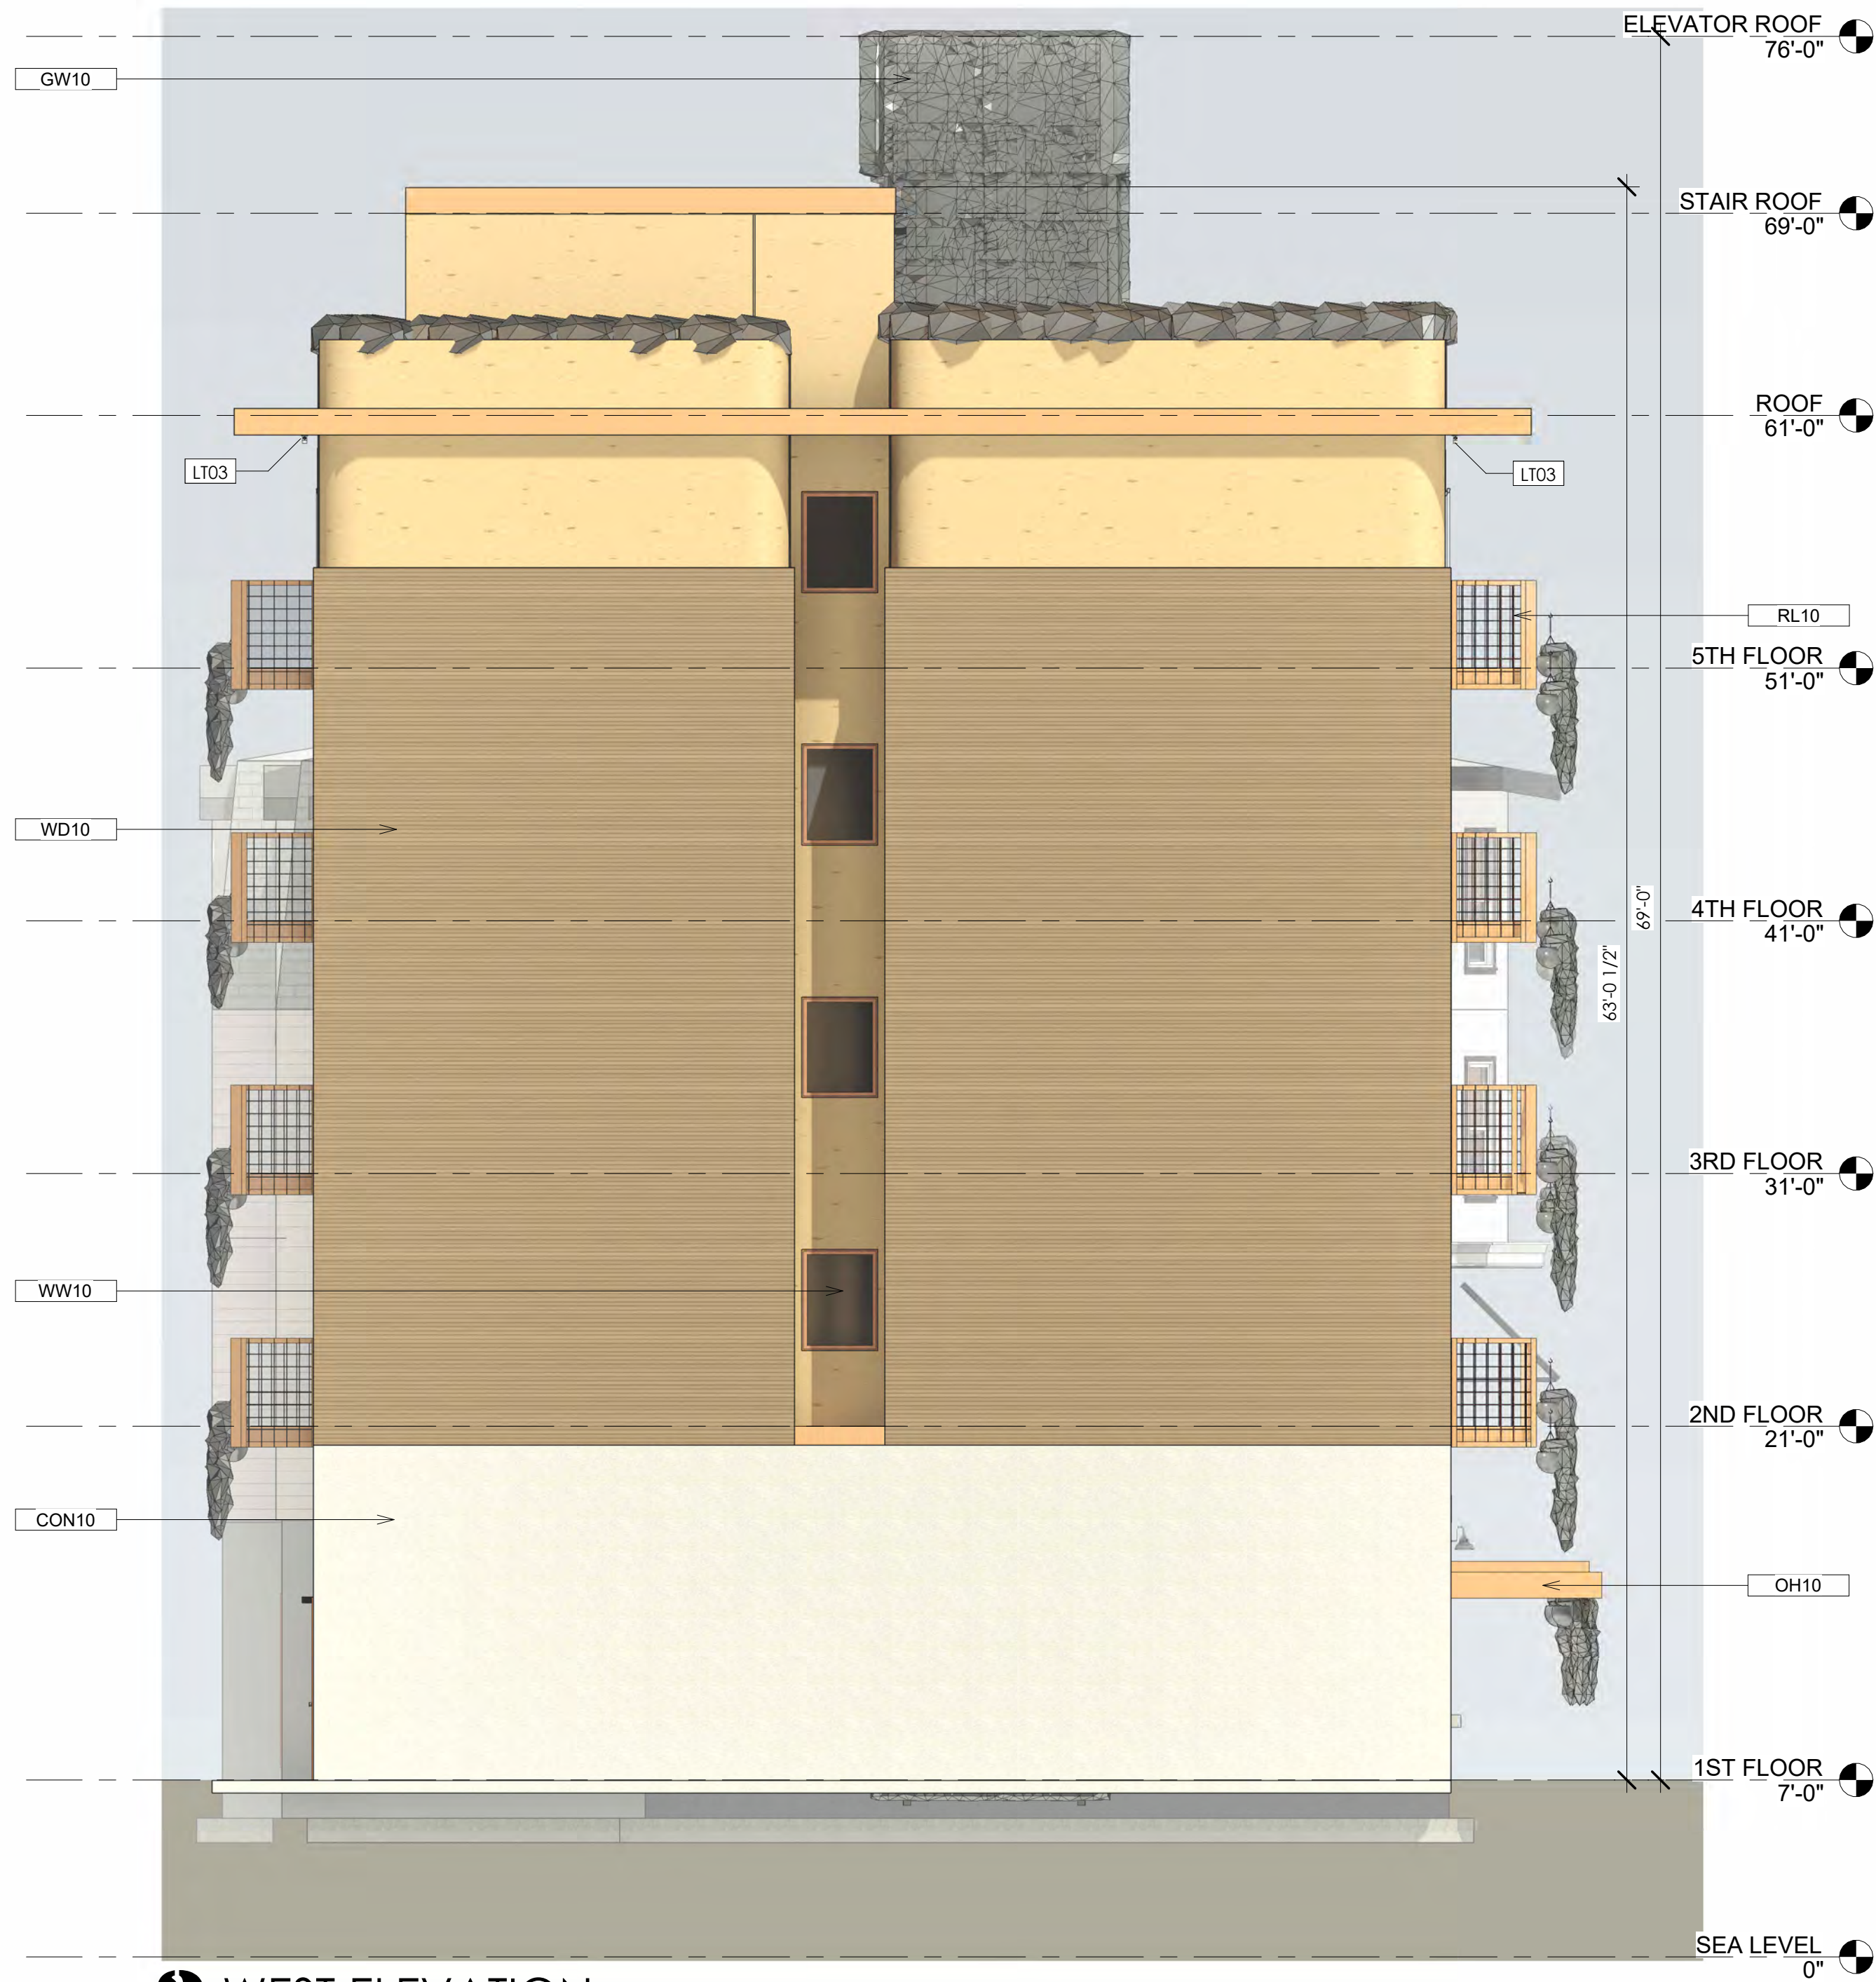

2 WEST ELEVATION
3/16" = 1'-0"

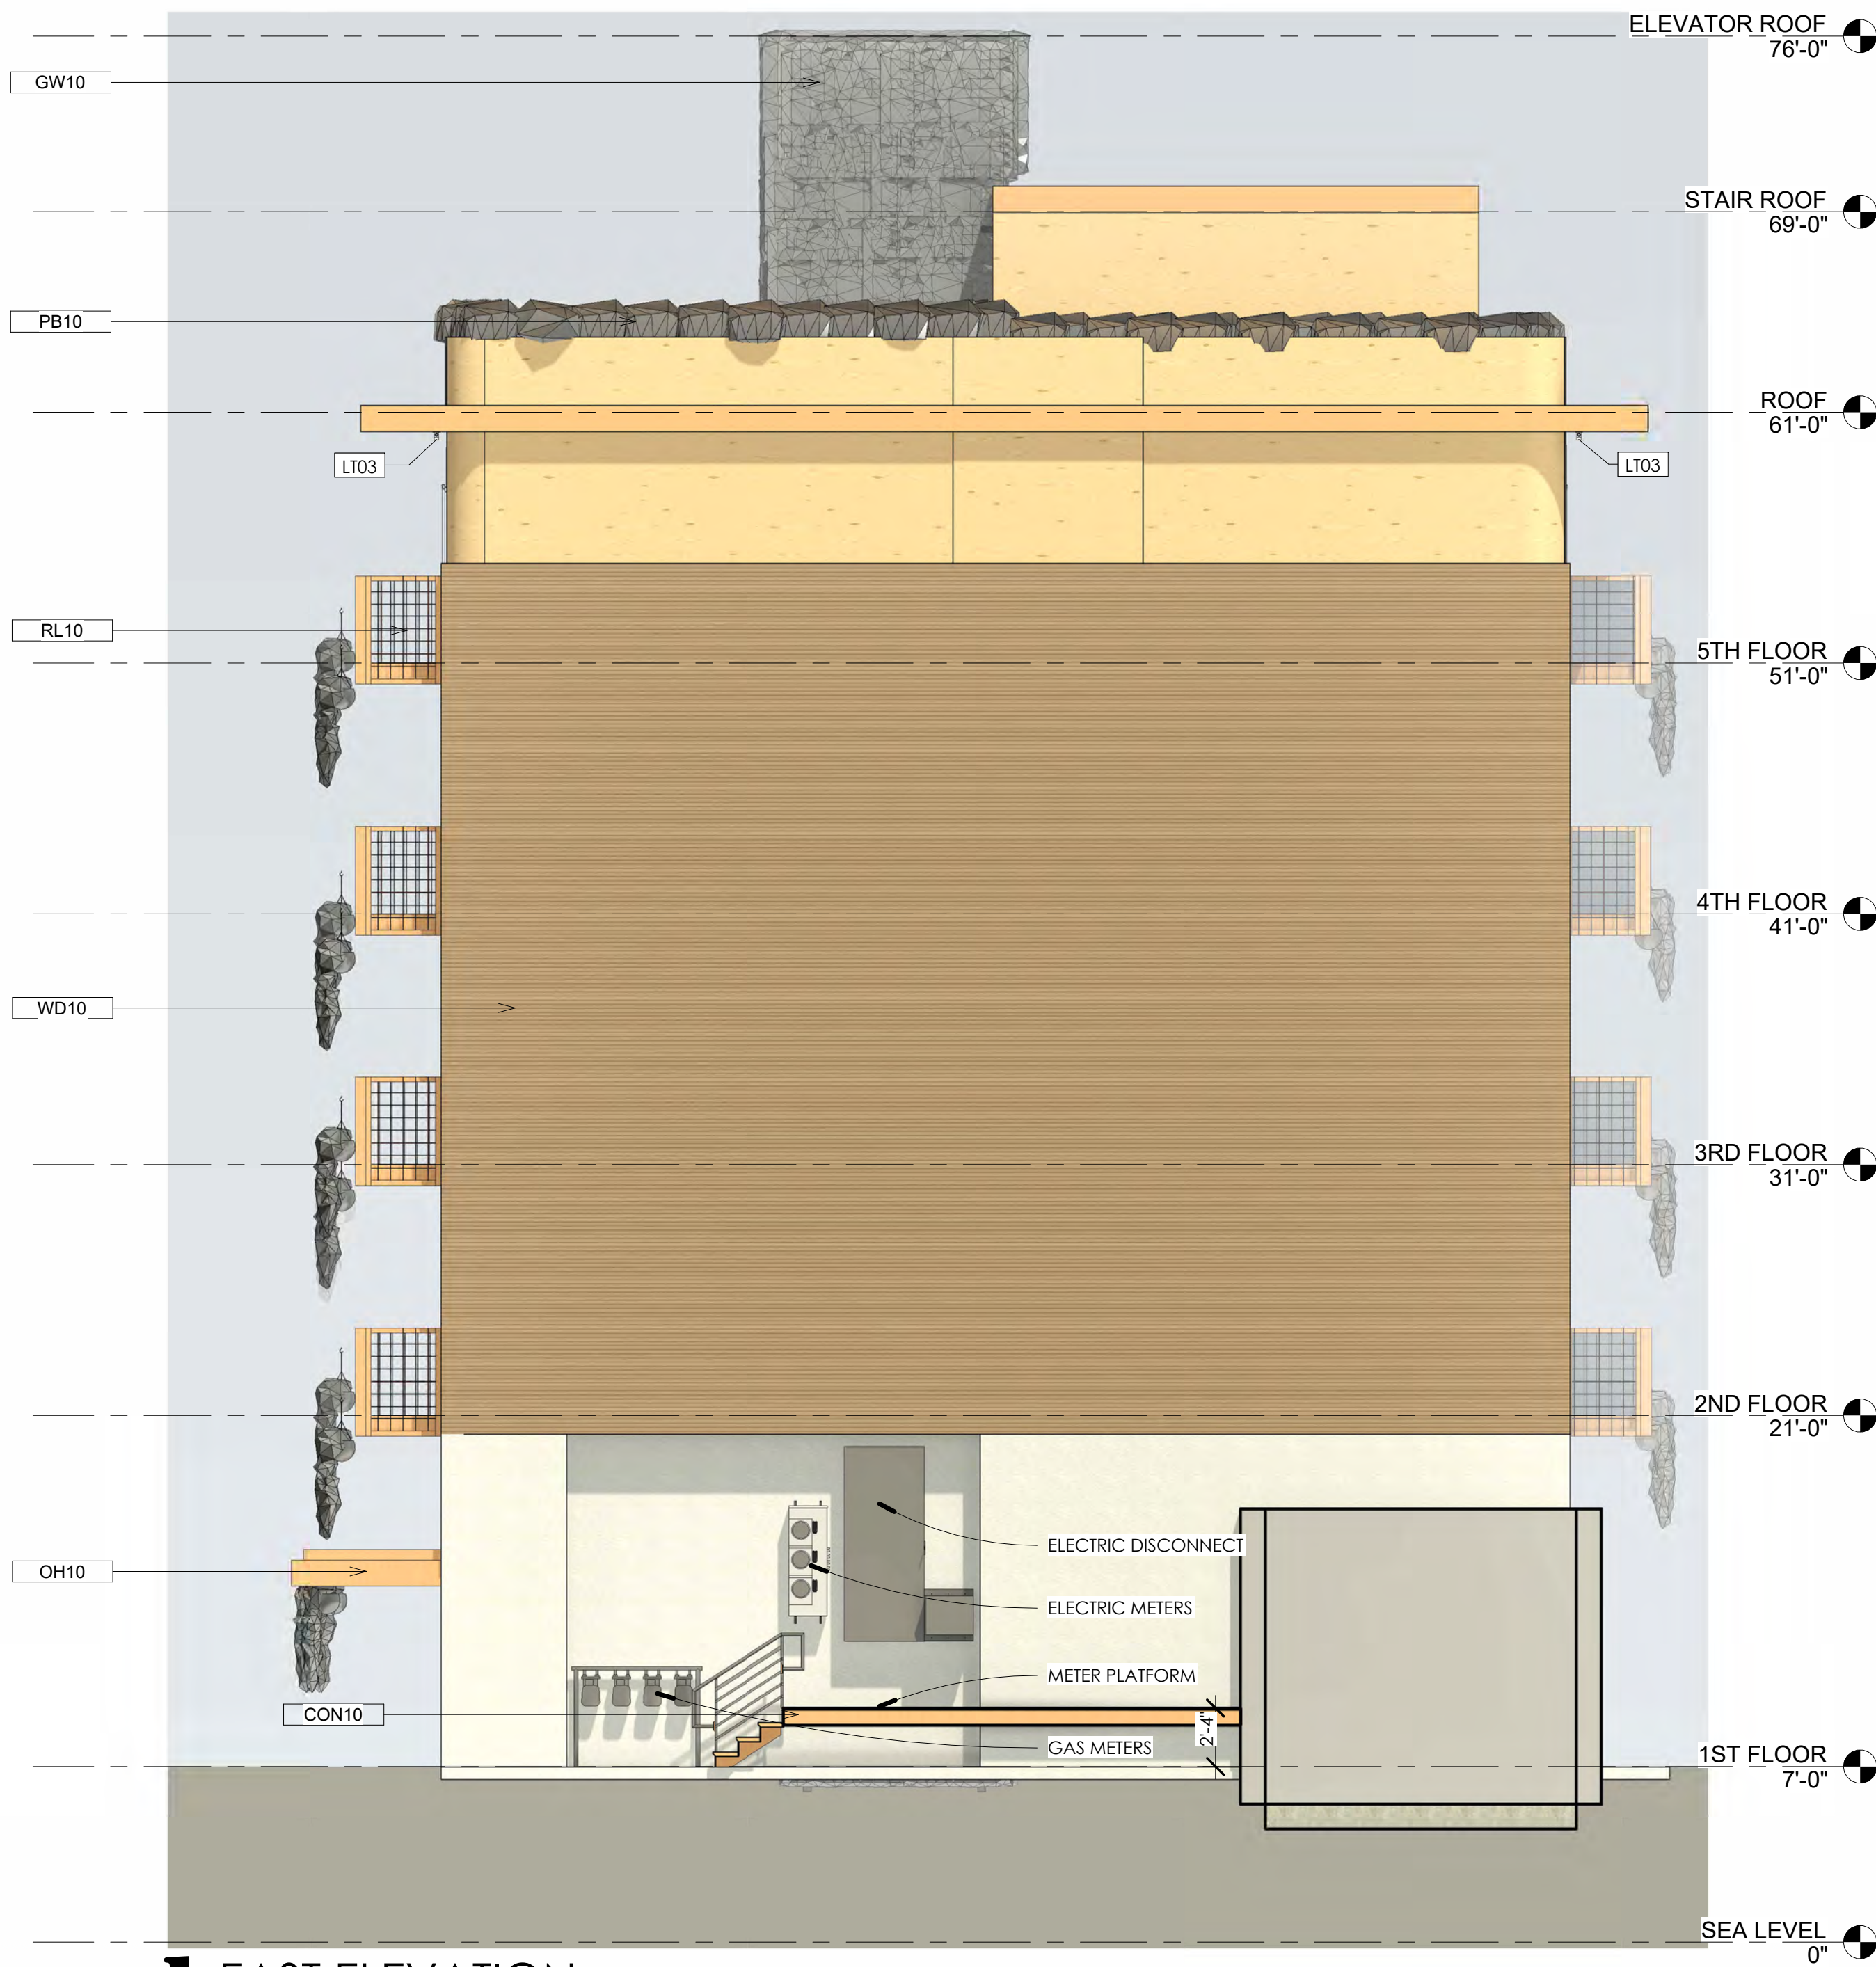

1 EAST ELEVATION
3/16" = 1'-0"

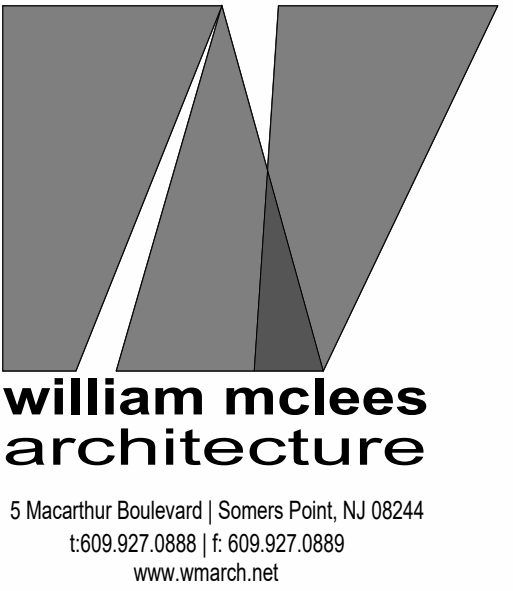

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NEW CONSTRUCTION SURF LODGE

BLOCK 54, LOTS 16 & 17
ATLANTIC CITY, NJ 08401

No.	Description	Date

ELEVATIONS

Scale 3/16" = 1'-0"
Drawn by WSZ
Date 10.05.22

A2.02

Comission no. 210865